



January 15, 1991

2CAN019103

U. S. Nuclear Regulatory Commission  
Document Control Desk  
Mail Station P1-137  
Washington, DC 20555

SUBJECT: Arkansas Nuclear One - Unit 2  
Docket No. 50-368  
License No. NPF-6  
Response to the NRC Request  
for Additional Information on the Inservice  
Inspection Program for Arkansas Nuclear One,  
Unit 2 (TAC No. 75836)

Gentlemen:

In letter 2CAN019005 (dated January 12, 1990), Entergy Operations submitted a summary of the second 10-year interval for the Inservice Inspection (ISI) Program for Arkansas Nuclear One, Unit 2 (ANO-2). During the review of this submittal, the NRC determined that additional information and/or clarification was required to complete the review and evaluation. The request for the additional information was transmitted to Entergy Operations in letter dated June 7, 1990 (2CNA069002).

The purpose of this letter is to provide the information and/or clarification requested in letter 2CNA069002. The format of this submittal is that the specific request is stated first and Entergy Operations' response is provided immediately after the request.

2.A. REQUEST

Provide an itemized listing of the welds/components subject to examination during the second 10-year interval for each system.

RESPONSE

An itemized listing of the welds and components subject to examination during the second 10-year interval is provided in Attachment 1. Attachment 1 is contained in the enclosed notebook.

9101240139 910115  
PDR ADOCK 05000368  
R PDR  
240021

A047 1/3

2.B. REQUEST

Provide isometric and/or component drawings showing the welds, components, and supports that Section XI of the ASME Code requires to be examined during the second 10-year interval. The isometric/component drawings, along with the requested weld/component listing, will permit the staff to determine if the extent of ISI examinations meets the applicable Code requirements.

RESPONSE

Isometric drawings with the corresponding ISI drawing number are provided in Attachment 2.

2.C. REQUEST

Discuss the specific exemptions applied during the second 10-year interval.

RESPONSE

The following exemptions have been applied:

IWB-1220 - Class 1 Components

- (a) Connections to the reactor coolant pressure boundary of such size that rupture is within the capacity of the makeup system.
- (b) (1) Piping NPS 1 inch and smaller, except for the steam generator tubing. (The steam generator tube surveillance is performed in accordance with ANO-2 Technical Specification 4.4.5 per IWB-2413.)  
  
(2) Components and their connections in piping of NPS 1 inch and smaller.
- (c) Reactor Vessel head connections and associated piping, NPS 2 inch and smaller, made inaccessible by CRD penetrations.

IWC-1220 - Class 2 Components

The exemptions per IWC-1221 are applied for components within the Shutdown Cooling, Safety Injection, and Containment Spray Systems.

The exemptions per IWC-1222 are applied for components within other Class 2 systems.

For piping support members and components encased in concrete, IWC-1230 has been applied.



IWD-1220 - Class 3 Components

The exemptions of IWD-1220.1 and IWD-1220.2 have been applied for Class 3 systems as allowed.

2.D. REQUEST

Provide a list of the Section XI ASME Code Cases that have been incorporated into the ISI Program Plan for the Arkansas Nuclear One, Unit 2, second 10-year interval. USNRC Regulatory Guide 1.147, "Inservice Inspection Code Case Acceptability, ASME Section XI, Division 1," Revision 7, lists the Section XI ASME Code Cases that are acceptable for application in the inservice inspection of components and their supports for water-cooled nuclear power plants.

RESPONSE

Attachment 3 provides a listing of the Code Cases in Regulatory Guide 1.147, Revision 7, that are to be utilized for the second 10-year ISI interval for ANO-2. If, during the interval, other Code Cases previously approved by the NRC are to be utilized, they will be appropriately referenced in the applicable procedures and will be included in a future revised ISI program submittal. Many of the Code Cases in Regulatory Guide 1.147 have been incorporated into the 1986 Code and are, therefore, not included in the listing. Additionally, the recently approved Code Case regarding the IWF Component Support Sampling Plan is utilized for component supports selection. When the Code Case has been published, a relief request will be submitted in accordance with 10 CFR 50.55a(g)(5).

2.E. REQUEST

Provide a list of the ultrasonic calibration standards being used during the second 10-year interval ISI at Arkansas Nuclear One, Unit 2. This list should include the calibration standard identifications, material specifications, and sizes.

RESPONSE

A copy of the controlling procedure for calibration standards is provided in Attachment 4. The procedure includes a listing of the calibration standards, identifying the material specifications, size, and weight.

2.F. REQUEST

Augmented examinations have been established by the NRC when added assurance of structural reliability is deemed necessary. Examples of documents which may require augmented examinations are:

- (1) High Energy Fluid Systems, Protection Against Postulated Piping Failures in Fluid Systems Outside Containment, Branch Technical Position ASB 3-1;
- (2) USNRC Regulatory Guide 1.150, Ultrasonic Testing of Reactor Vessel Welds During Preservice and Inservice Examinations;

- (3) I&E Bulletin 79-17, Pipe Cracks in Stagnant Borated Water Systems at PWR Plants.

Address these and any other augmented examinations which may have been incorporated in the Arkansas Nuclear One, Unit 2, Second 10-year Interval Inservice Inspection Program Plan.

#### RESPONSE

Augmented examinations for the second 10-year interval include the following:

(NOTE: These examinations are not included in the component listing.)

- Internal Handling Fixture Tripod and Turn Buckle: NUREG-0602, Control Of Heavy Loads
- Reactor Coolant Pump Studs: INPO SOER-81-12
- Critical Piping: SAR 10.3.2.1
- Reactor Coolant Pump Motor Flywheels: Regulatory Guide 1.14 and ANO-2 Technical Specification 4.4.10
- Thermal Stresses in Piping Connected to Reactor Coolant Systems: NRC Bulletin 88-08

Other regulatory or vendor recommended requirements, including Branch Technical Position ASB 3.1, Regulatory Guide 1.150 and NRC Bulletin 79-17, are being reviewed to identify additional augmented examinations. These items will be included in a future revised ISI Program submittal.

#### 2.G. REQUEST

Relief Request 1 - Relief is requested from the ASME Code-required surface examination of Class 1 piping welds 06-001, 06-002, 07-001, 07-002, 09-001, 09-002, 11-001, 11-002, 13-001, 13-002, 15-001, and 15-002 because they are inside the primary shield wall and are inaccessible for O.D. surface examinations. The Licensee has proposed the use of ultrasonic techniques, from the I.D. surface, to examine the outside surface of the subject welds in lieu of the Code-required surface examination.

This proposal could be considered acceptable provided that the Licensee meets the following conditions:

- (1) The remote volumetric examination includes the entire weld volume and heat affected zone instead of only the inner one-third of the weld as required by the Code.

- (2) The ultrasonic testing instrumentation and procedures are demonstrated to be capable of detecting O.D. surface-connected defects in the circumferential orientation in a laboratory test block. The defects should be cracks and not machined notches.

Provide a discussion of the above conditions and verify that they will be met.

## 2.H. REQUEST

Relief Request 2 - Relief is requested from performing the inservice volumetric examination from the nozzle side of all branch piping nozzle welds to the main coolant piping. The staff has recently noted significant improvements in the techniques being used for volumetric examinations from the branch connection side of the Class 1 welds. List the specific welds for which relief is requested and the percentage of the Code-required volumetric examination that can and will be performed for each of the subject welds, and discuss what efforts Arkansas Power and Light Company has made to perform the Code-required volumetric examination from the branch connection side of the subject welds.

## 2.I. REQUEST

The relief requests were submitted in two different formats. The relief requests submitted in the tabular format (ASME CLASS-1 AND -2 COMPONENTS NDE INSERVICE INSPECTION RELIEF REQUESTS FOR ANO-2 BASED ON ASME SECTION XI-1986 CODE) should be revised as several relief requests in a format similar to Relief Requests 1 and 2 (e.g., one for each Examination Category). Since the relief requests in the table are in the form of a summary, adequate descriptive and detailed technical information is not provided.

When revising these relief requests, the justification should include the following as a minimum:

- (1) Section XI Code Examination Category, Code Item Number, and Code-required examination;
- (2) Section XI Code requirement from which relief is requested;
- (3) identification of the specific welds/components for which relief is requested, including the percentage of the Code-required examinations that can and will be completed on each weld/component;
- (4) proposed alternative examinations planned
  - (a) in lieu of the Section XI requirements, or
  - (b) to supplement Section XI partial examinations;
- (5) technical discussion which demonstrates that the Code requirement is impractical (drawings, sketches, or photographs may be used).



Appendix F, Article F-3000, "Substitute Examinations or Tests" of the 1989 Edition of the ASME Code Section XI may also be used for guidance when preparing the relief requests.

2.G. RESPONSE

2.H.

2.I. These three items requested additional information on the Relief Requests included in our January 12, 1990, submittal. Due to recent organizational changes within Entergy Operations, particularly the establishment of a Nondestructive Examination group, we believe that further review of modifications and advances in examination techniques is warranted prior to requesting relief in the second 10-year interval and providing additional information on previously requested relief. We propose that a future submittal, by the end of the first inspection period (March 26, 1993), will provide the detailed relief requests. At that time, the format of the relief requests will be consistent with your recommendations.

It should be noted that these relief requests are not required for the first inspection period.

ADDITIONAL INFORMATION

Snubber Inspection


ANO-2 Technical Specification 4.7.8 addresses the visual and functional inspections of the snubbers. We are currently pursuing a clarification, by a technical specification change, to state that the inspections would be in accordance with the specified surveillance in Technical Specification 4.7.8 in lieu of Technical Specification 4.0.5 (ISI). We believe this approach more adequately complies with the requirements of 10 CFR than an ISI Program Relief Request. Integrally-welded attachments to snubber supports will continue to be included within the scope of the ISI Program, but snubber inspections will be performed under a separate program.

Relief Requests for First 10-year Inspection Interval

As a result of a review of the examinations included in the first 10-year inspection interval, relief from certain Code requirements were identified. In accordance with 10 CFR 50.55a(g)(5), these relief requests are submitted in Attachment 5.

We believe the information provided in this submittal will allow the Staff to complete its review and evaluation of the ANO-2 ISI Program. Should you have any questions regarding this issue, please contact me.

Very truly yours,

  
James J. Fisicaro  
Manager, Licensing

JJF/RWC/kdr  
Attachments

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LIST OF ATTACHMENTS


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|--------------|--|
| Attachment 1 | Itemized Listing of Welds and Components   |
| Attachment 2 | Isometric Drawings   |
| Attachment 3 | Code Cases Utilized in ISI Program   |
| Attachment 4 | Procedure 1092.193 - Administrative Control of<br>Inservice Inspection (ISI) Calibration Standards |
| Attachment 5 | First 10-Year Interval Relief Requests   |




ATTACHMENT 1

ITEMIZED LISTING OF WELDS AND COMPONENTS

ATTACHMENT 2  
ISOMETRIC DRAWINGS

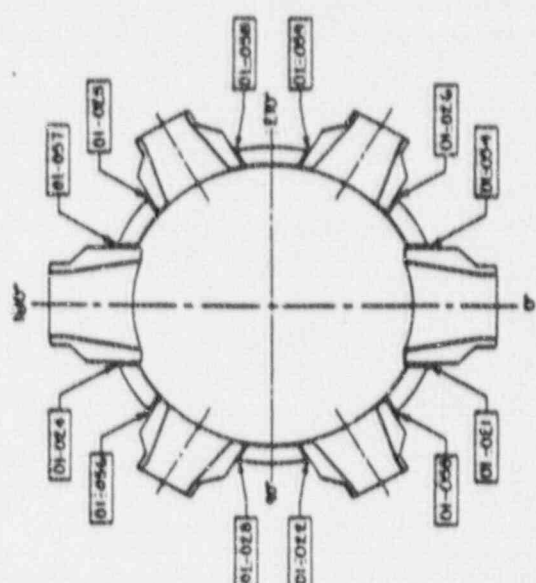


SECTION B-B

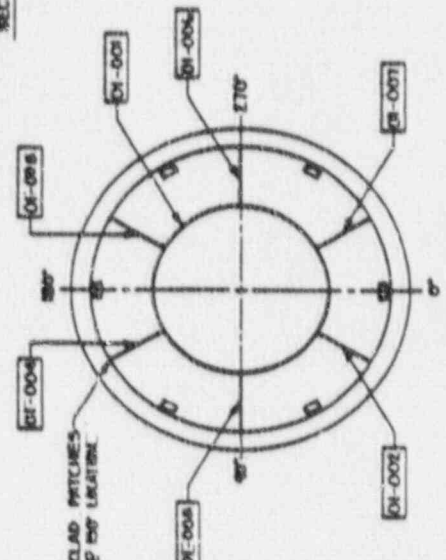

SECTION A-A

- MALET NOZZLE INNER RADIUS AREA
  - 01-009 @ 60° LOCATION
  - 01-004 @ 120° LOCATION
  - 01-001 @ 240° LOCATION
  - 01-002 @ 300° LOCATION
- MALET NOZZLE INNER RADIUS AREA FROM 00
  - 01-001 @ 60° LOCATION
  - 01-002 @ 120° LOCATION
  - 01-004 @ 240° LOCATION
  - 01-002 @ 300° LOCATION

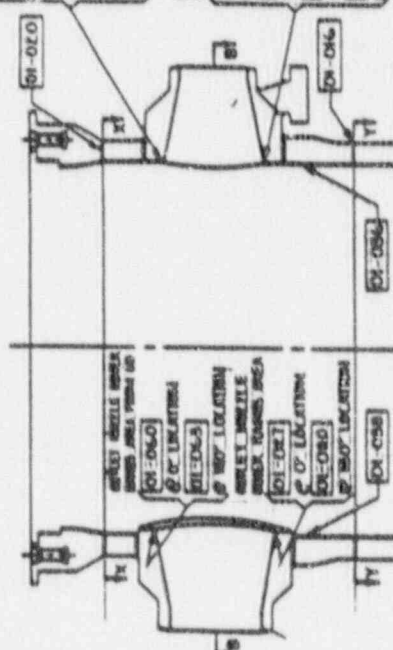

- INTERNAL SUPPORT (SAMBUR)
  - 01-002 @ 0° LOCATION
  - 01-003 @ 60° LOCATION
  - 01-004 @ 120° LOCATION
  - 01-001 @ 180° LOCATION
  - 01-002 @ 240° LOCATION
  - 01-003 @ 300° LOCATION

- CORE STOP LUGS
  - 01-050 @ 225° LOCATION
  - 01-051 @ 150° LOCATION
  - 01-052 @ 75° LOCATION
  - 01-053 @ 150° LOCATION
  - 01-054 @ 225° LOCATION

- SAMBUR BETA
  - 01-006 @ 60° LOCATION
  - 01-007 @ 120° LOCATION
  - 01-008 @ 300° LOCATION

NO.	REV.	DATE	BY	CHKD
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DESIGNED PER ISL

PROJECT NO. 100-1000

SCALE: AS SHOWN

REACTOR VESSEL WELD DESIGNATIONS ZONE 01





ARLANS POWER AND LIGHT COMPANY

ARLANS NUCLEAR ONE

UNIT 2

ISI - 201



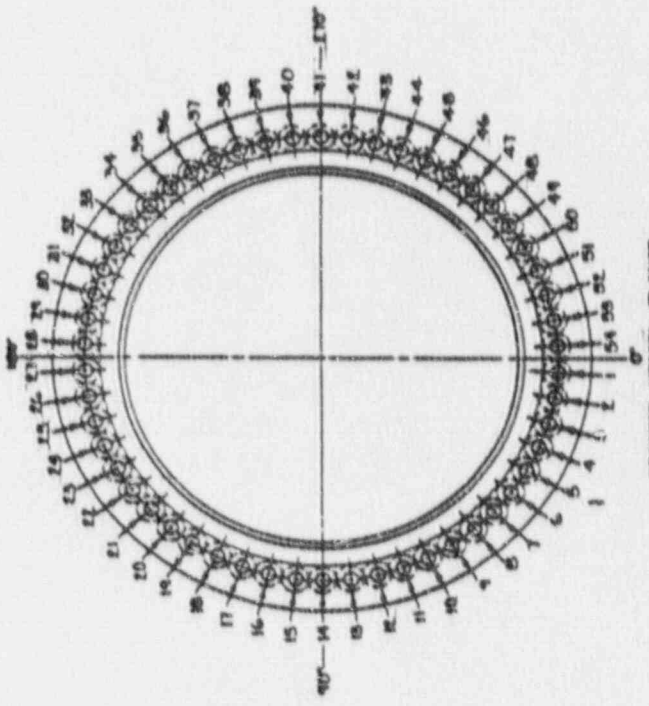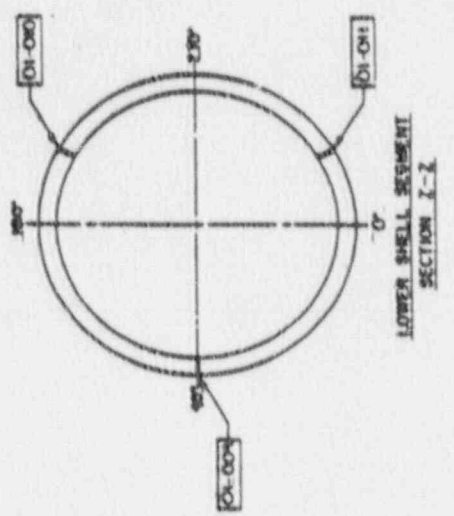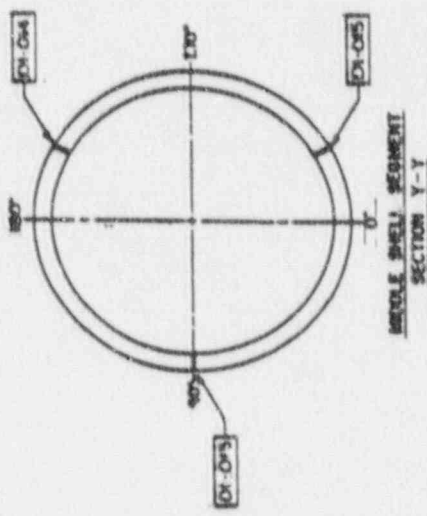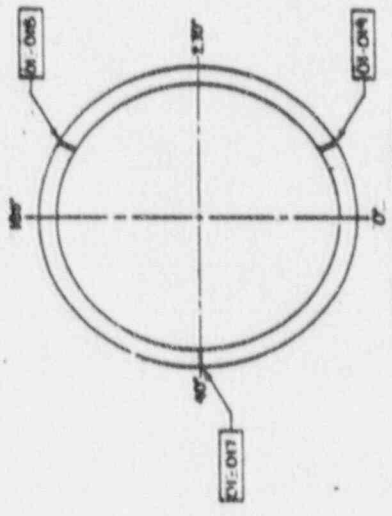

LIGAMENT DESIGNATIONS

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7	01-L-7	34	01-L-34
8	01-L-8	35	01-L-35
9	01-L-9	36	01-L-36
10	01-L-10	37	01-L-37
11	01-L-11	38	01-L-38
12	01-L-12	39	01-L-39
13	01-L-13	40	01-L-40
14	01-L-14	41	01-L-41
15	01-L-15	42	01-L-42
16	01-L-16	43	01-L-43
17	01-L-17	44	01-L-44
18	01-L-18	45	01-L-45
19	01-L-19	46	01-L-46
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FOR	ENGINEERING
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DESIGNED BY	W. S. [Signature]
CHECKED BY	[Signature]
APPROVED BY	[Signature]
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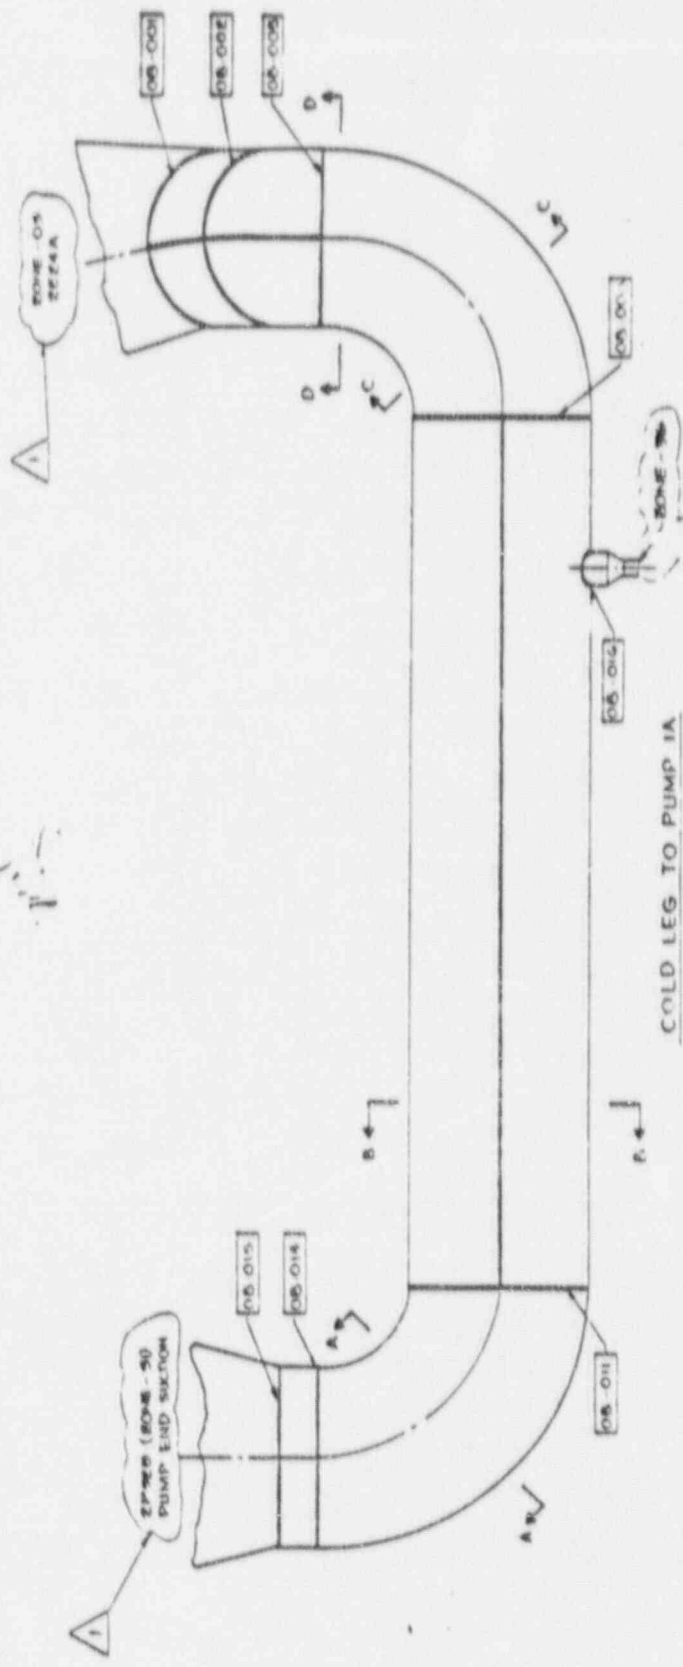
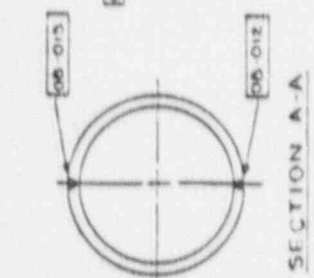
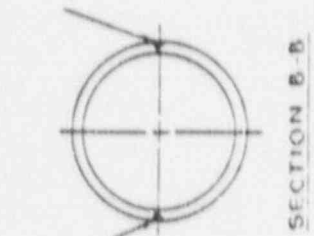
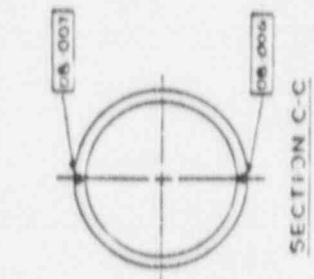
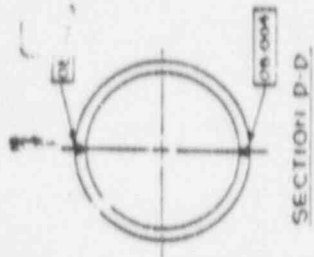












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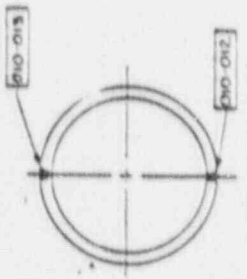
ARIZONA POWER AND LIGHT COMPANY  
 ARIZONA NUCLEAR ONE  
 UNIT 2

COLD LEG STEAM GEN. #1  
 TO PUMP IA  
 ZONE-08


ISI-203

PIPE LINE CLAS - 2244-9  
 PIPE LOCATION - 2244-9  
 PIPE CONNECT TO - 2244-9  
 PIPE DIA - 12.75" - 12.75"  
 PIPE WALL THICKNESS - 0.1875"  
 WELD PROC REQUIRED TO SAUGH  
 SIDE OF WELD







SECTION A-A

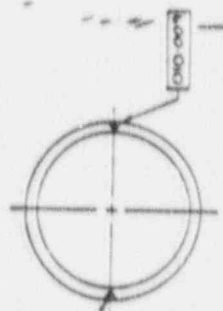


SECTION B-B

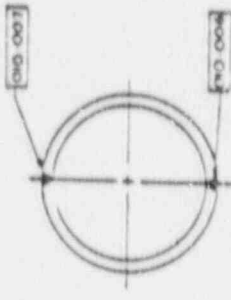

SECTION C-C

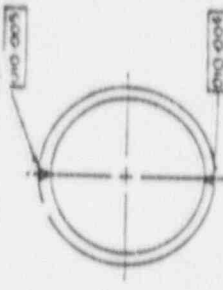

SECTION D-D

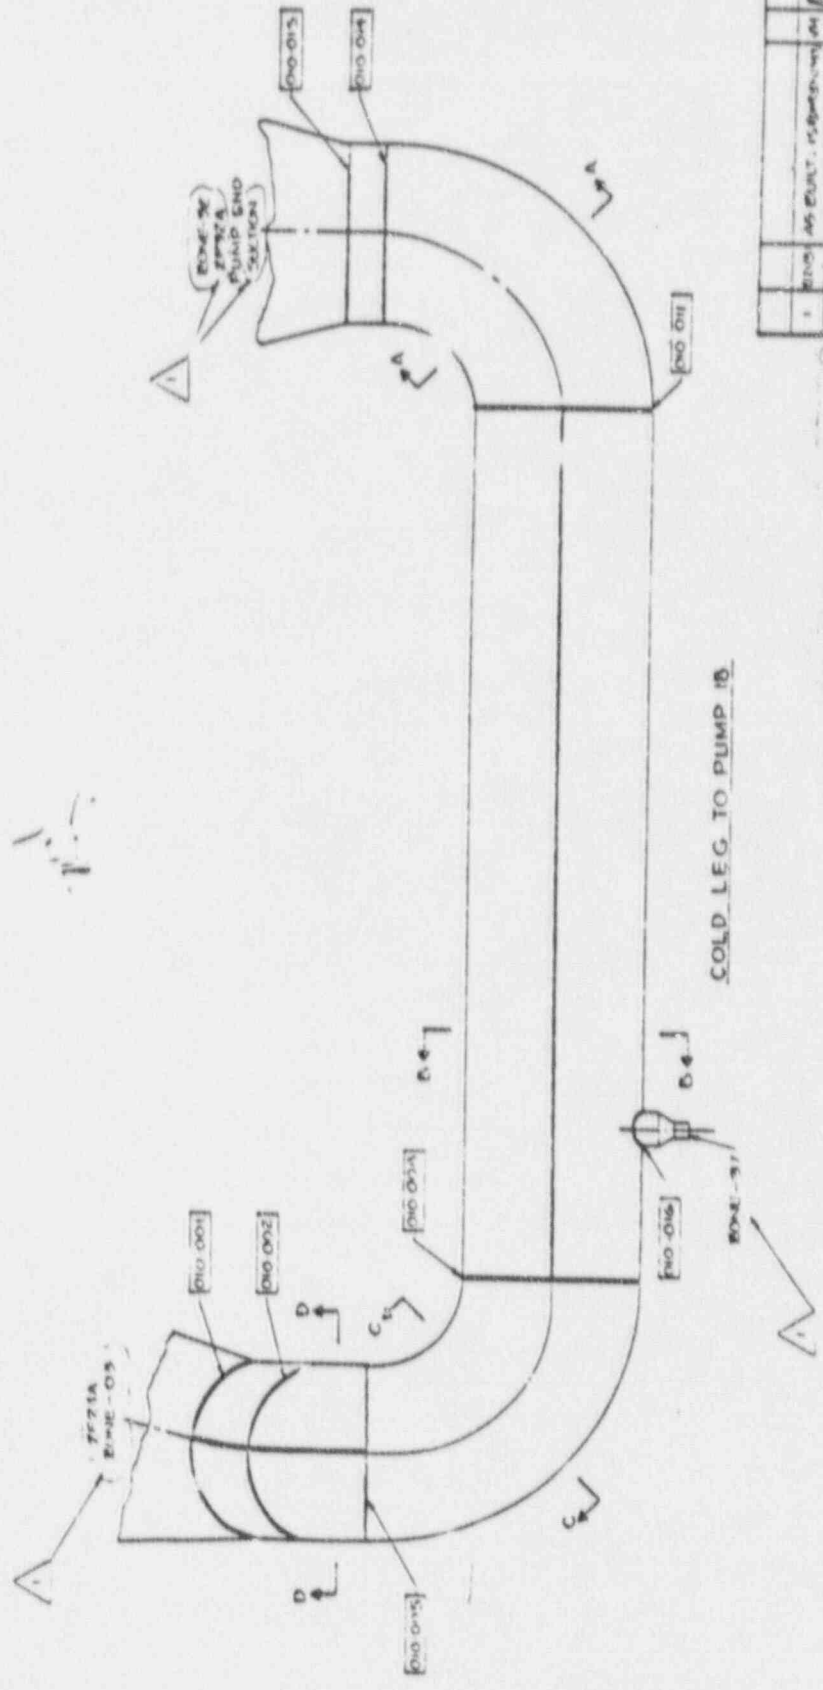

PIPE LINE CLASS - B22A-9  
 PIPE LOCATION - 875' - 934' ELEV  
 PIPE CONNECTS TO - B22ES - 0819Z.47  
 PIPE DIAMETER - 80"  
 PIPE WALL THICKNESS - 8.0"  
 WELD PROCESS REQUIRED - TIG  
 SIDE OF WELD


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ARKANSAS POWER AND LIGHT COMPANY ARKANSAS NUCLEAR ONE UNIT 2 COLD LEG STEAM GEN. #01 TO PUMP 1B ZONE 10 DRAWING NO 151-210 REV 1					








SECTION A A

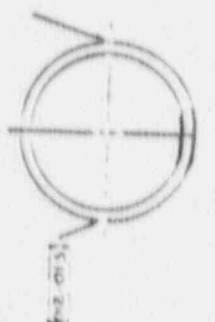


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SECTION C C



SECTION D D

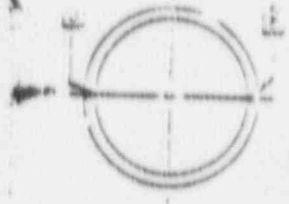


COLD LEG TO TRIMS 2A

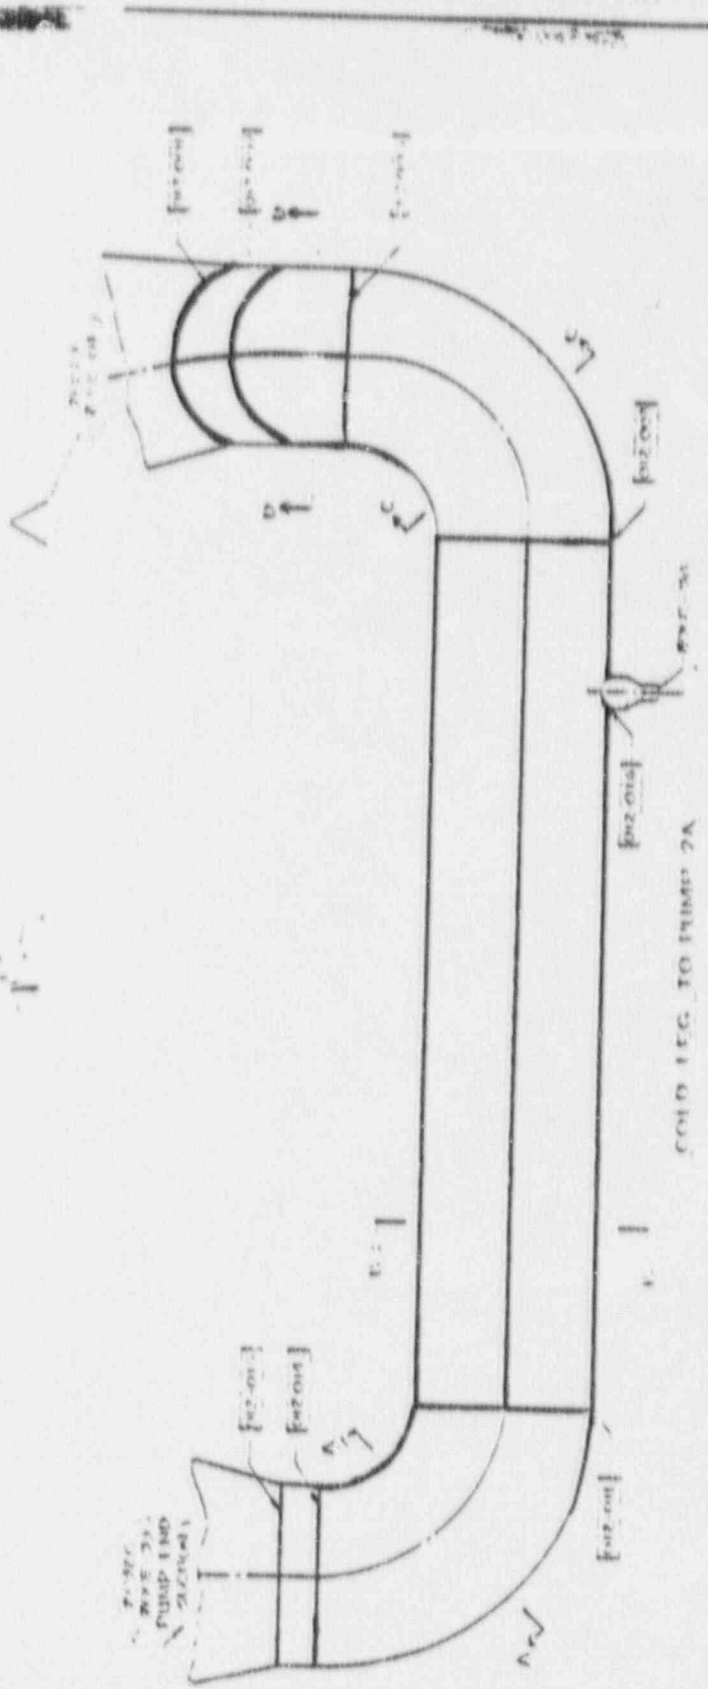
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- (PIPE CHARACTERISTICS - 400.1)
- (PIPE DIMENSIONS - 400.1)
- (PIPE WALL THICKNESS - 400.1)
- (MATERIAL SPECIFICATION - 400.1)
- (SIZE OF WELD)

STEEL	STEEL	STEEL	STEEL
WELDS	WELDS	WELDS	WELDS
VALVES	VALVES	VALVES	VALVES
FLANGES	FLANGES	FLANGES	FLANGES
TEES	TEES	TEES	TEES
ELBOWS	ELBOWS	ELBOWS	ELBOWS
UNITS	UNITS	UNITS	UNITS


CHILD I.F.G. STEAM GEN #2  
TO PUMP 2A  
709F-12  
1.3-21

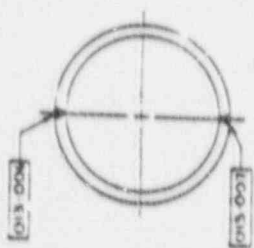

SECTION A-A

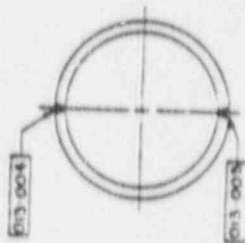


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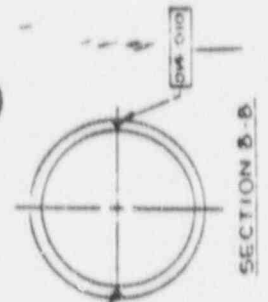
COLD LEG 2A TO REACTOR VESSEL  
TOP VIEW

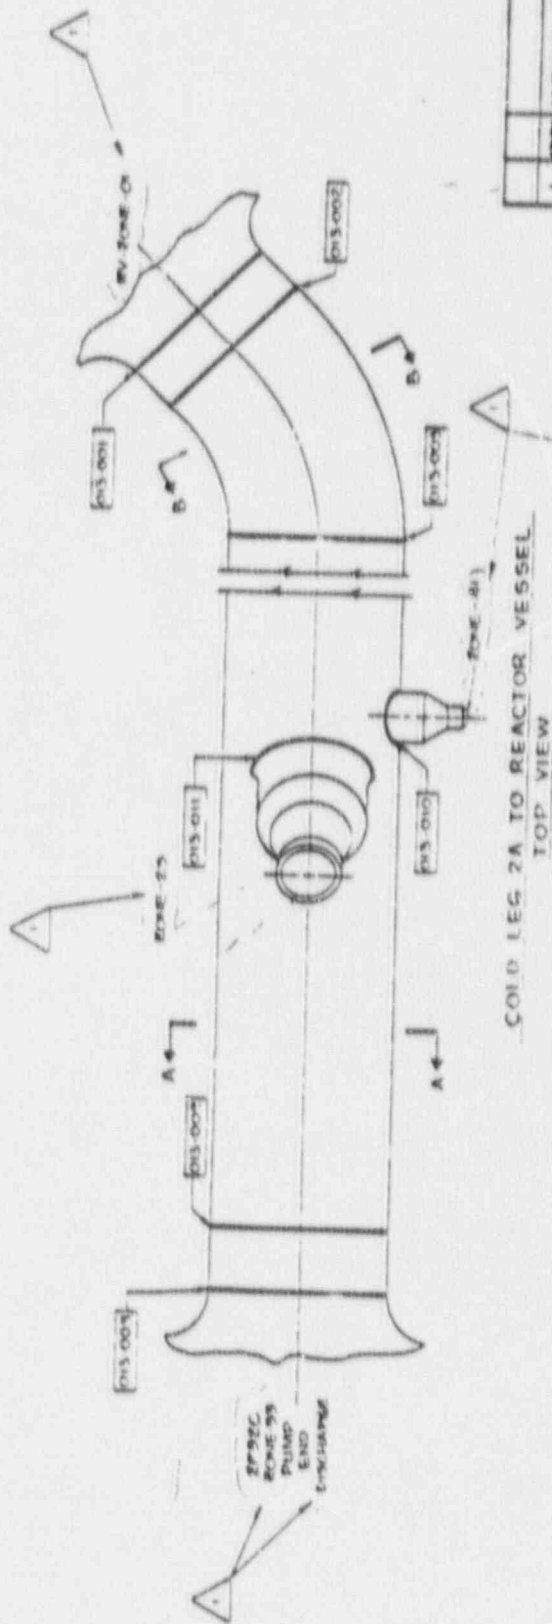PIPE LINE CLASS - 2000  
 PIPE LOCATION - 2000  
 PIPE CONNECTIONS TO SOURCE - 2000  
 PIPE INSULATION - 2000  
 PIPE WALL THICKNESS - 9.850"  
 WELD PIPES REQUIRED - 76" EACH  
 SIDE OF VESSEL


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COLD LEG PUMP 2A TO REACTOR VESSEL ZONE-13			
DRAWING NO		REV	REV
ISI-213			1




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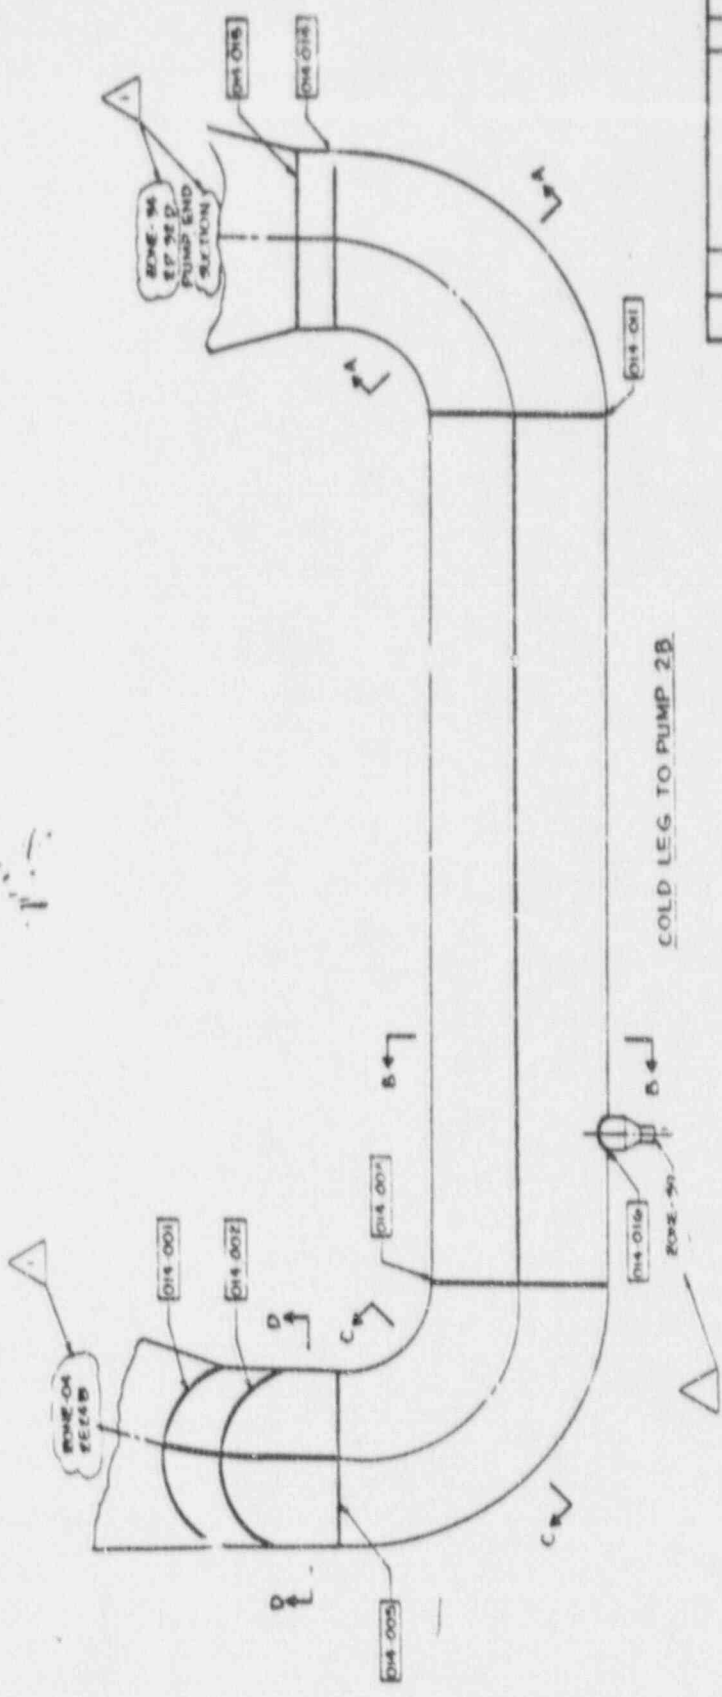
SECTION B-B

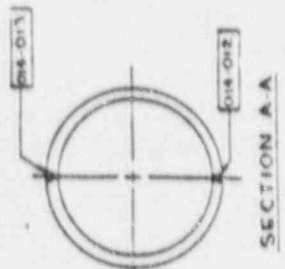

SECTION C-C

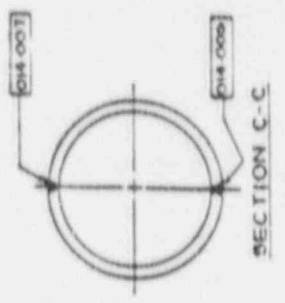

SECTION D-D

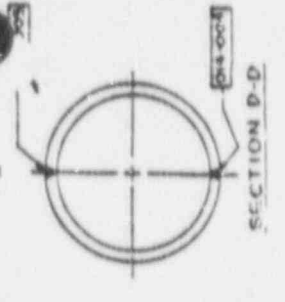

COLD LEG TO PUMP 2B

PIPE LINE CLASS - B/A-B  
 PIPE LOCATION - 574' - 595' ELEV  
 PIPE CONNECTS TO - SCHEM-OA 56, 4 98  
 PIPE DIAMETER - 30"  
 PIPE THICKNESS - 5/8"  
 WELD PREP REQUIRED - T.O. EACH  
 5/8" OF WELD

DATE	BY	CHKD	APP'D	REVISION
10/1/50	J. H. ...	J. H. ...	J. H. ...	1
10/1/50	J. H. ...	J. H. ...	J. H. ...	2
10/1/50	J. H. ...	J. H. ...	J. H. ...	3
10/1/50	J. H. ...	J. H. ...	J. H. ...	4
10/1/50	J. H. ...	J. H. ...	J. H. ...	5
10/1/50	J. H. ...	J. H. ...	J. H. ...	6
10/1/50	J. H. ...	J. H. ...	J. H. ...	7
10/1/50	J. H. ...	J. H. ...	J. H. ...	8
10/1/50	J. H. ...	J. H. ...	J. H. ...	9
10/1/50	J. H. ...	J. H. ...	J. H. ...	10

ARKANSAS POWER AND LIGHT COMPANY  
 ARKANSAS NUCLEAR ONE  
 UNIT 2

COLD LEG STEAM GEN # 2  
 TO PUMP 2B  
 ZONE - 14

ISSUED NO. 151-214  
 REV. 1


















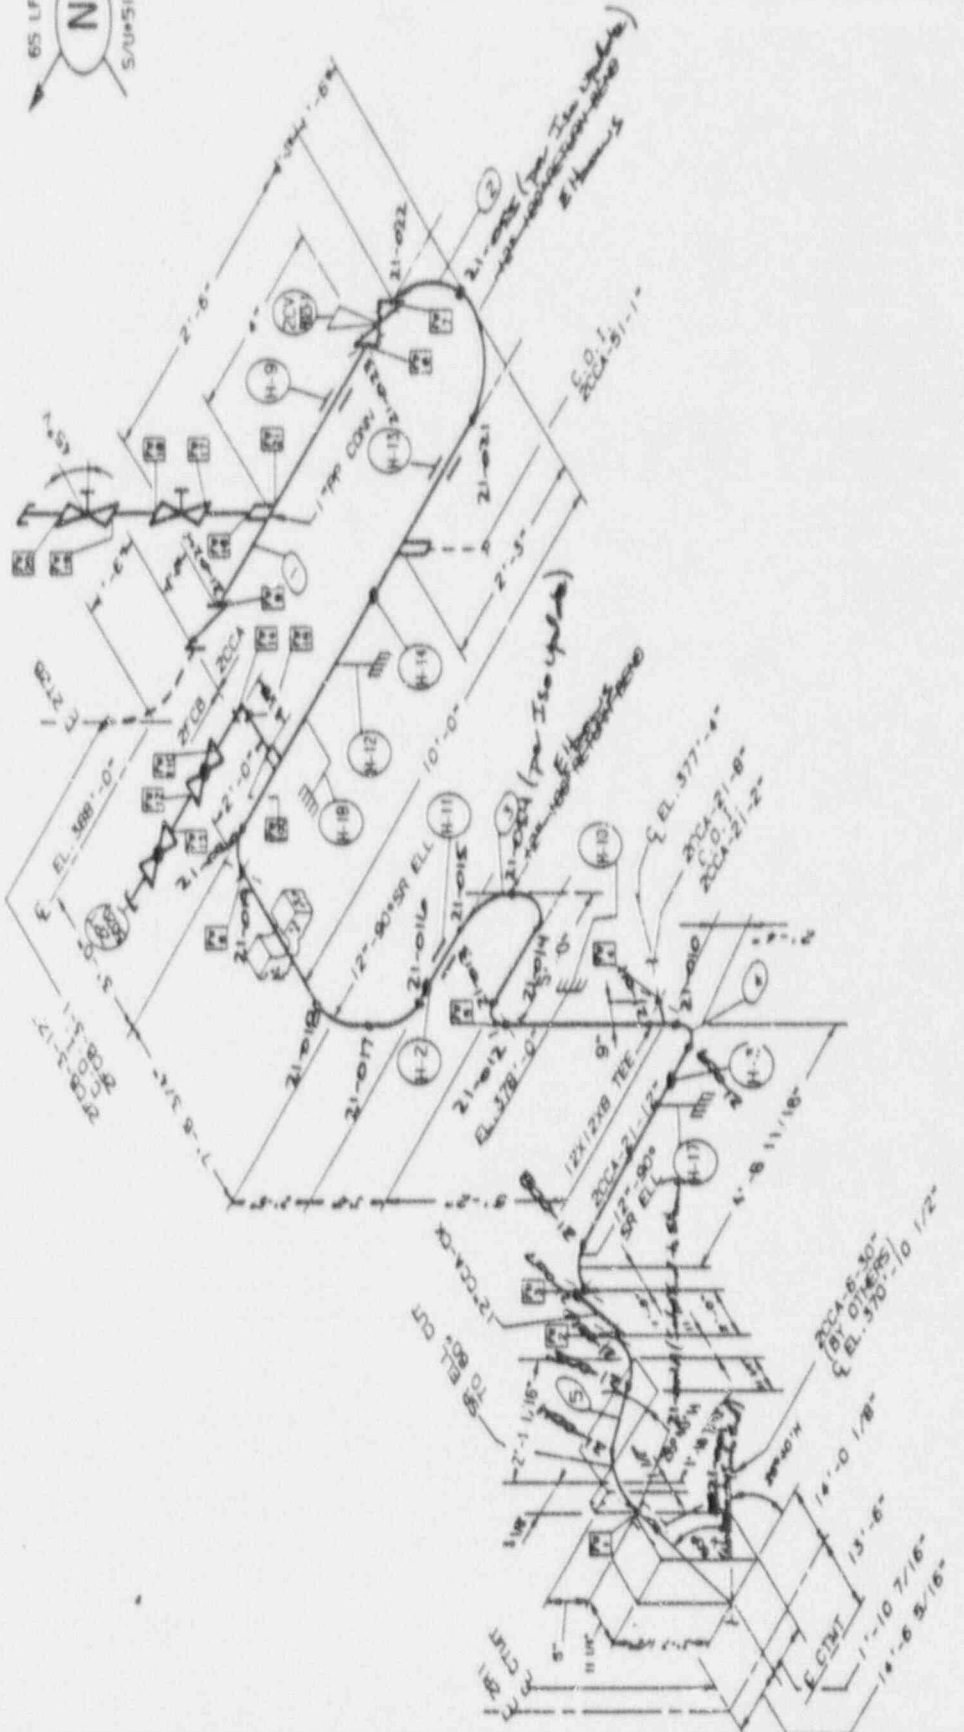

ITEM	QTY	DESCRIPTION	HEAT NO.	ASTM	GRD
13	1	6000 SW VALV O/L	SA-182		7-318
12	1	7/8\"/>			
11	1	6000 SW VALV O/L	SA-182		7-318
10	1	6000 SW VALV O/L	SA-182		7-318
9	4	1/2\"/>			
8	5	1/2\"/>			
7	1	1/2\"/>			
6	2	1/2\"/>			
5	1	1/2\"/>			
4	1	1/2\"/>			
3	1	1/2\"/>			
2	1	1/2\"/>			
1	1	1/2\"/>			

REFERENCE

P.B.L. NO. M-22501-M-2232  
 PIPING DWG. M-20051-M-2056  
 AREA NO. 25  
 BLDG. REACTOR BLDG.  
 SYS. SAFETY INJECTION SYSTEM

OWNER TYPE: ARKANSAS POWER AND LIGHT COMPANY  
 UNIT: ARKANSAS NUCLEAR ONE

NAME: LARGE PIPE ISOMETRIC  
 DRAWING NO.: 20CA-21-1

SYS. CLEANING HEIGHT: PSIG  
 SERVICE CONDITIONS: PSIG

STARTUP NO. INSULATION CLASS THICK

SCALE: 1/4\"/>

ISI-221














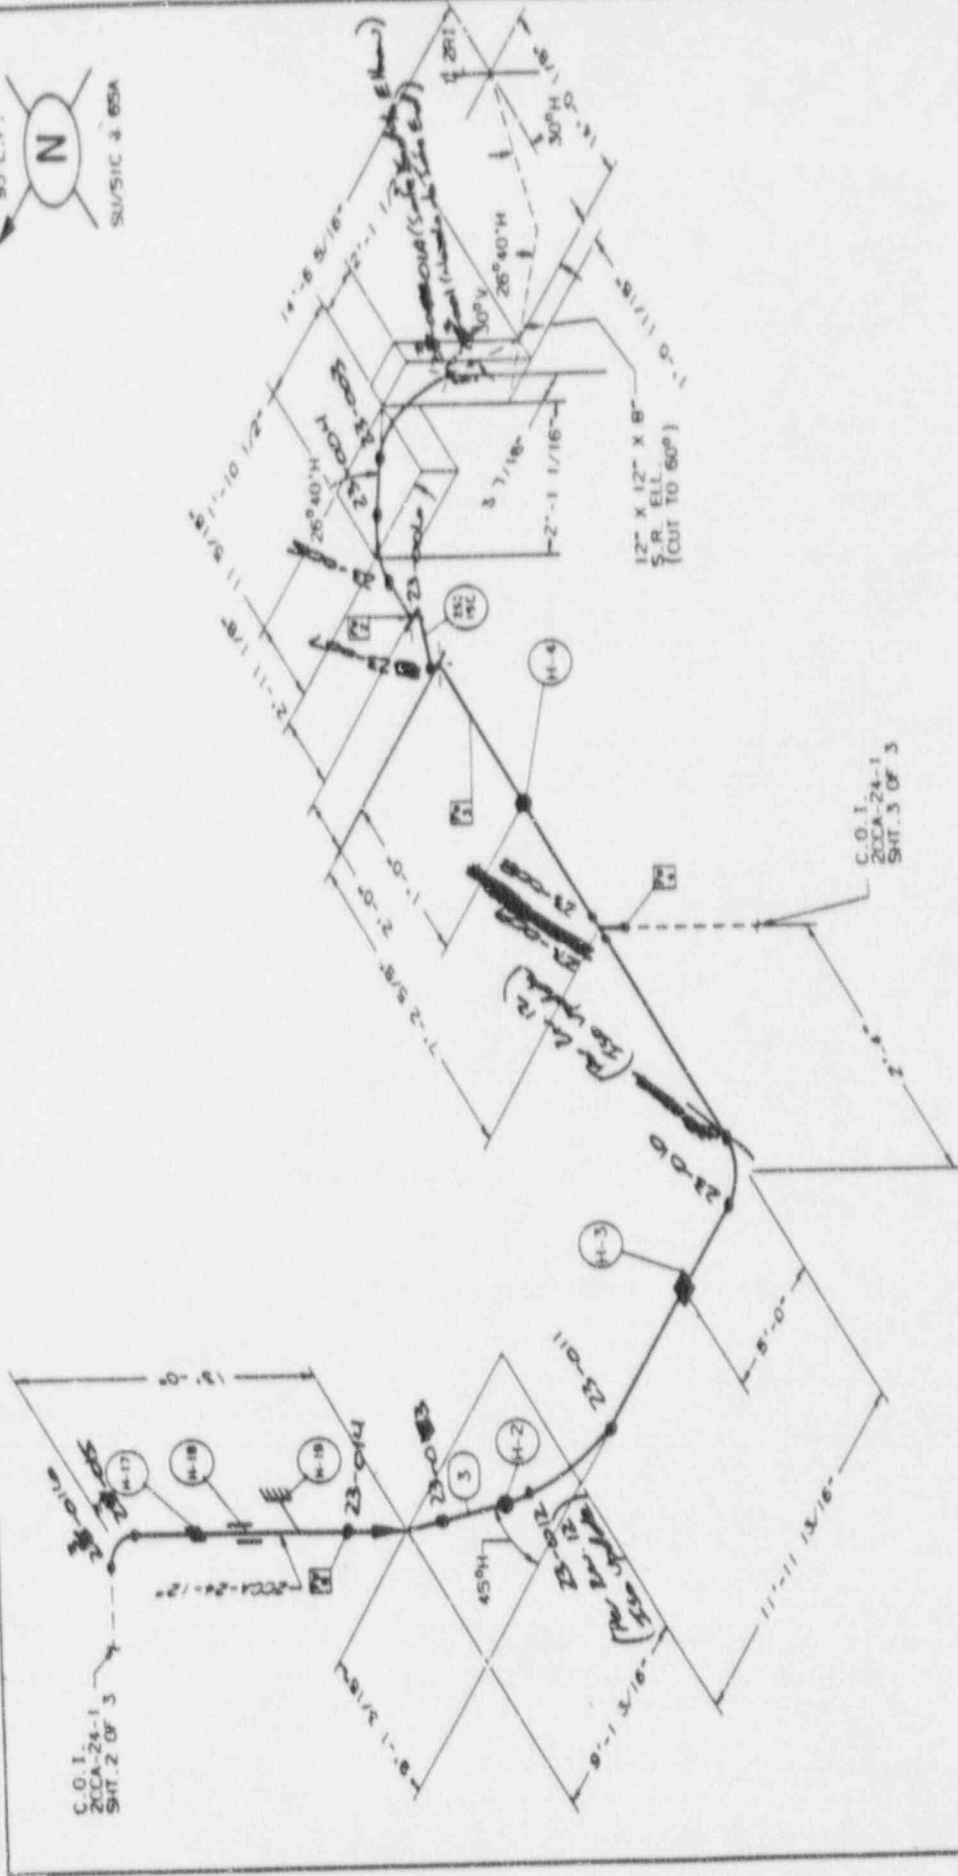

ITEM	QTY	DESCRIPTION	HEAT NO	ASTM	GRID
13	1	1\"/>			
14	1	1\"/>			
15	1	1\"/>			
16	4	3/8\"/>			
17	1	1\"/>			
18	1	1\"/>			
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100	1	1\"/>			

REFERENCE	
PLAN NO.	M-2230-M-2232
PIPING DWG.	M-2006(M)-2005
AREA NO.	25
BUILDG.	REACTOR BUILDING
SYS.	SAFETY INJECTION SYSTEM
HANGER TYPE	
DWG. NO.	
SYS. CLEARING NO.	
SERVICE CONDITIONS	
NORMAL	
MAXIMUM	

BILL OF MATERIAL	
STARTUP NO.	
INSULATION CLASS	
THICK	
ITEM	QTY
DESCRIPTION	
HEAT NO	
ASTM	
GRID	

ARKANSAS POWER AND LIGHT COMPANY  
 UNIT 2  
 LARGE PIPE ISOMETRIC  
 SAFETY INJECTION SYSTEM  
 20CA-24-1  
 ISI-223












SU/SIC & BSA

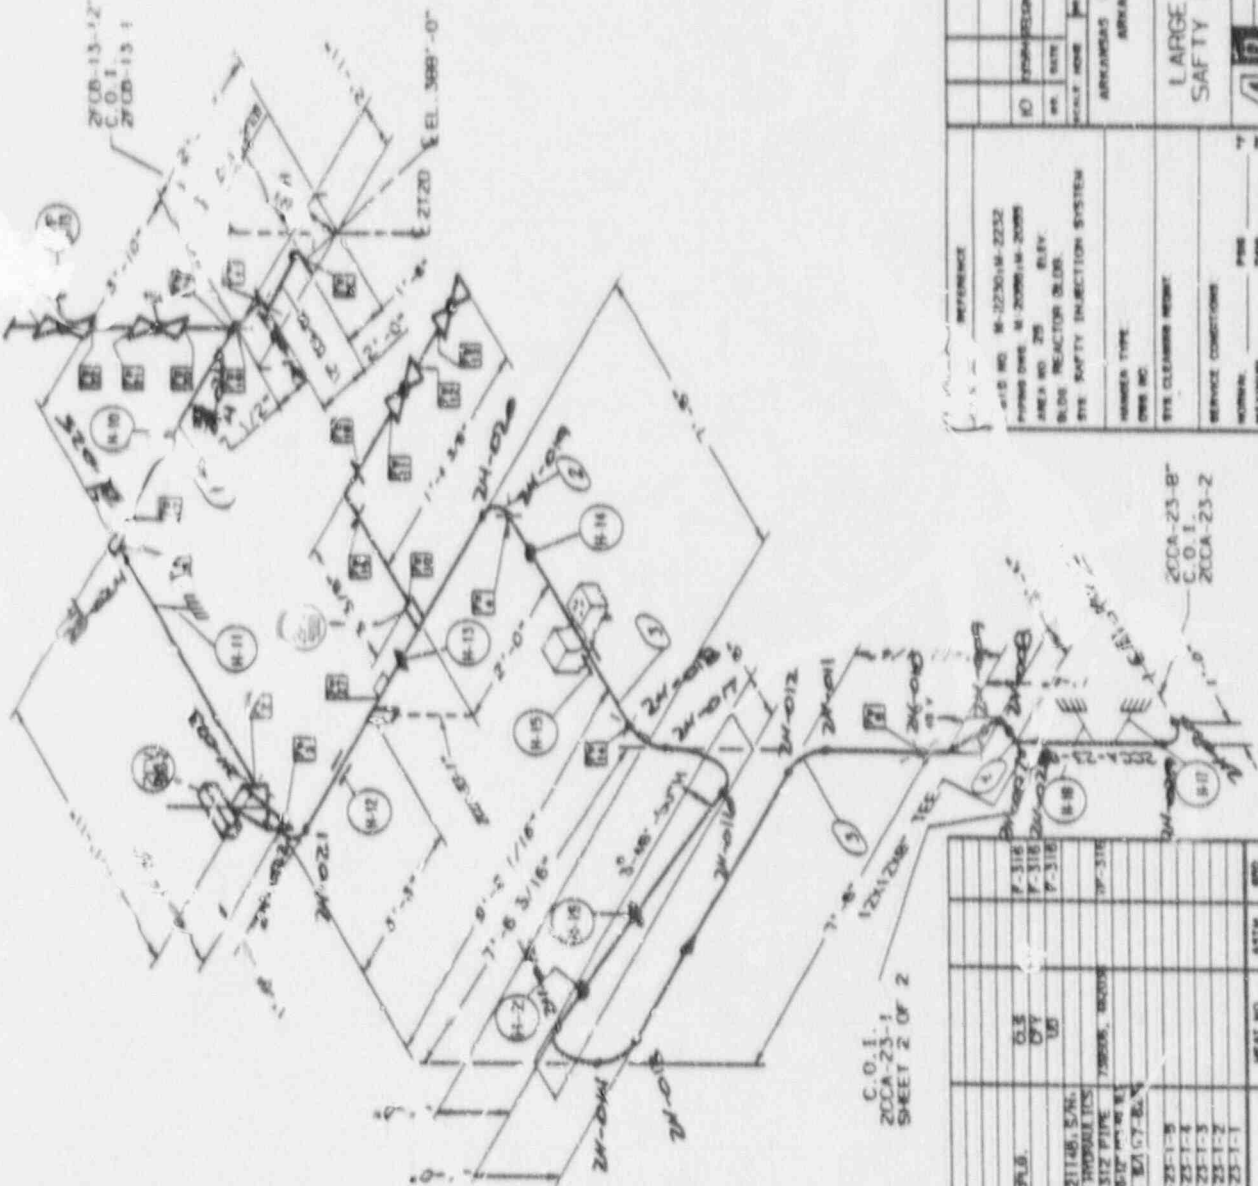

C.O.I.  
20CA-23-1  
SHEET 2 OF 2

REFERENCE	418 NO. 14-223016-2232
FIGURE NO.	14-223016-2095
AREA NO.	25
BLDG. NO.	REACTOR BLDG.
SYSTEM	SAFETY INJECTION SYSTEM
UNIT	ARKANSAS POWER AND LIGHT COMPANY ARKANSAS NUCLEAR ONE UNIT 2
SCALE	AS SHOWN
DATE	10/1/68
BY	W. J. HARRIS
CHECKED BY	J. W. HARRIS
APPROVED BY	

ITEM NO.	DESCRIPTION	QUANTITY	UNIT
1	1" 8000-54-182 8" W. HALF DR.L.B.	1	EA
2	1" 8000-509615 CAP SA-182	1	EA
3	1" 8000-8" W. 80" ELL SA-182	1	EA
4	1" W. 203-88 VALVES, P.O. W. 2114B, S/N: 1803, 1837, 1833, 1813, WESTON HYDRAULICS	4	EA
5	1" W. P. & S. P. E. 825 180 SA 312 PIPE	1	EA
6	12" 23-883-2, P.K. 84-225 8.5, 508 18 85 12" W. 2112-02, SA 312-8	1	EA
7	12" COCA-28, P.O. W. 2112-02, SA 312-8	1	EA
8	1-2024, ATWOOD MERRILL	1	EA
9	PIPE SPKOL MARK NO. 51-200A-25-1-9	1	EA
10	PIPE SPKOL MARK NO. 51-200A-25-1-4	1	EA
11	PIPE SPKOL MARK NO. 51-200A-25-1-3	1	EA
12	PIPE SPKOL MARK NO. 51-200A-25-1-2	1	EA
13	PIPE SPKOL MARK NO. 51-200A-25-1-1	1	EA

ITEM NO.	DESCRIPTION	QUANTITY	UNIT
14	20CA-23-B C.O.I.	1	EA
15	20CA-23-2	1	EA

ISI-224



115 LF



- REV 3 NOTE  
REPLACE 5" WELDRIB BY 6" x 6" W  
END THE 8" x 3" CONC. RCP.
- REV 4 NOTE  
RECALCULATED 24" x 36" WAS 18"
- REV 5 NOTE  
REPLACE 6" CONC. VALVE 0" 37" H  
8" DIA. 18" WAS 18"
- REV 6 NOTE  
DELETED CONN TO ISO 2CCA-96.17  
8" REV TO HYDROSTATIC DRAIN

REV 2 NOTE  
11" DIA. WAS 11" DIA. 18" DIA. WAS 18"  
17" DIA. WAS 17" DIA. 20" DIA. WAS 20"  
REFERENCE DRAWINGS  
M-2250 REV. 21 P. 10  
M-2252 - 20 PIPING PLAN AREA 25  
M-2051 - 11


NO.	DATE	DESCRIPTION	BY	CHKD.
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**BECHTEL**  
SAN FRANCISCO 3

**ARABAS POWER & LIGHT COMPANY**  
ARABAS NUCLEAR ONE  
UNIT 2

ISOMETRIC - CONTAINMENT 2-5G  
SAFETY JECCITION

66002 2CCA-23 9

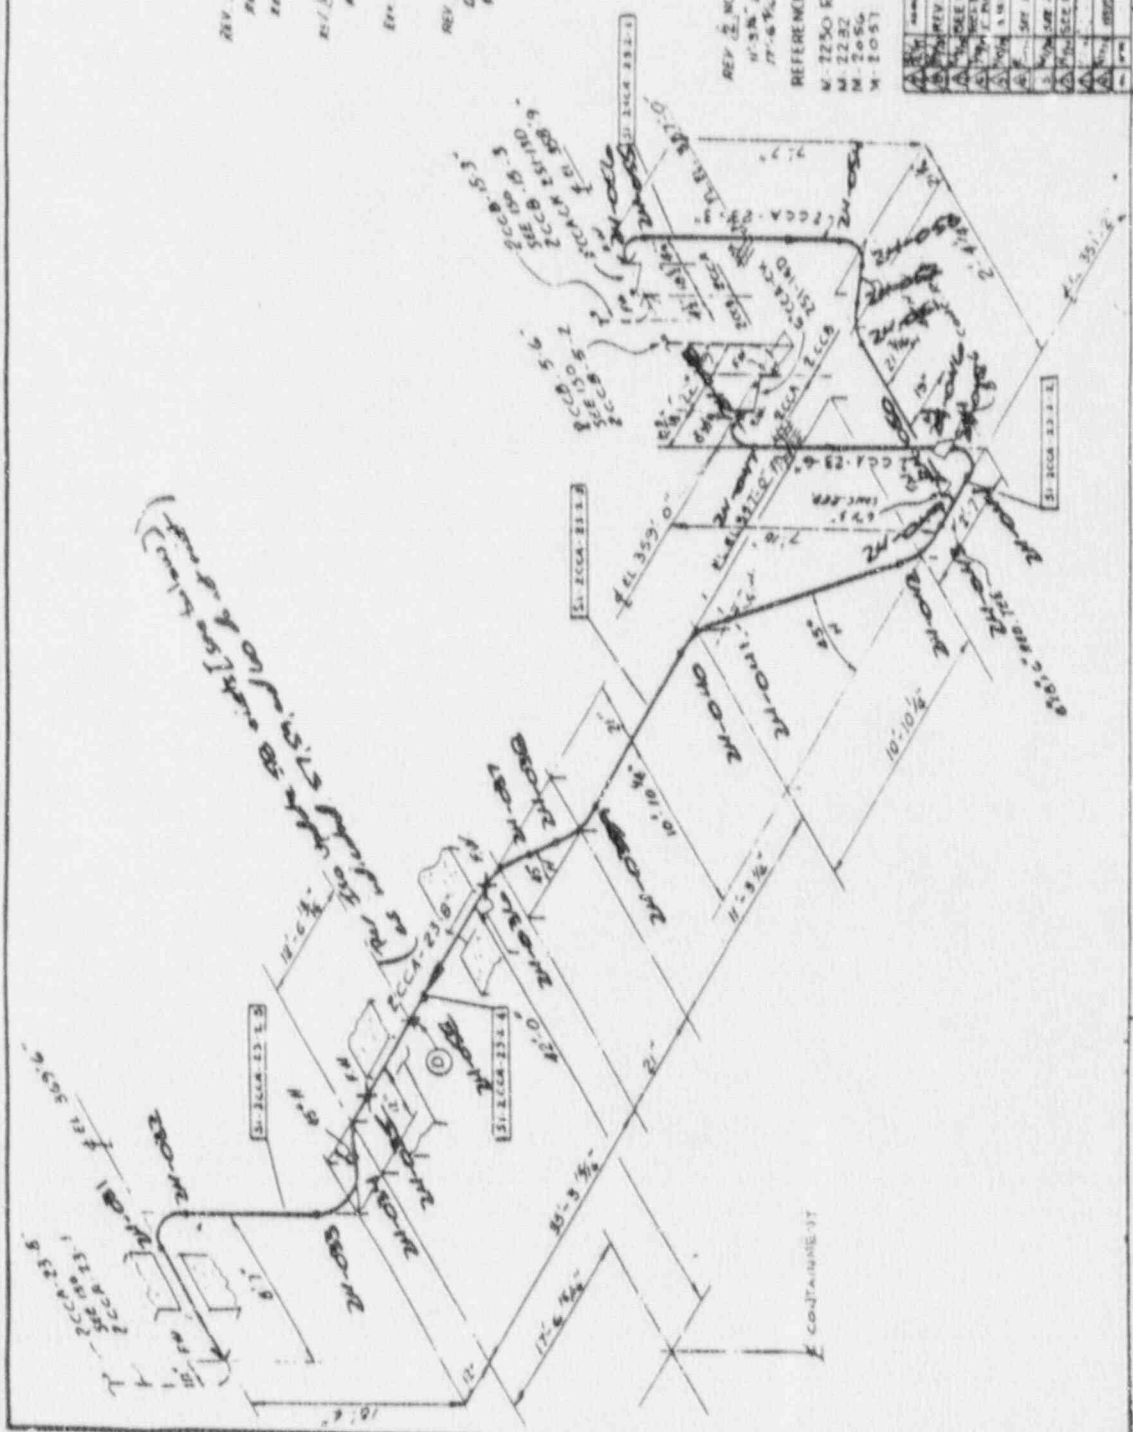

**BILL OF MATERIALS**


NO.	DESCRIPTION
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2	PIPE 24" DIA. 10' L. 2CCA-23.2
3	PIPE 24" DIA. 10' L. 2CCA-23.3
4	PIPE 24" DIA. 10' L. 2CCA-23.4
5	PIPE 24" DIA. 10' L. 2CCA-23.5
6	PIPE 24" DIA. 10' L. 2CCA-23.6
7	PIPE 24" DIA. 10' L. 2CCA-23.7
8	PIPE 24" DIA. 10' L. 2CCA-23.8
9	PIPE 24" DIA. 10' L. 2CCA-23.9
10	PIPE 24" DIA. 10' L. 2CCA-23.10
11	PIPE 24" DIA. 10' L. 2CCA-23.11
12	PIPE 24" DIA. 10' L. 2CCA-23.12
99	PIPE 24" DIA. 10' L. 2CCA-23.99
100	PIPE 24" DIA. 10' L. 2CCA-23.100

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I certify that the image contained on this frame was made in the normal and regular course of business, on the date stated below and that it is true and correct.

**A C W**



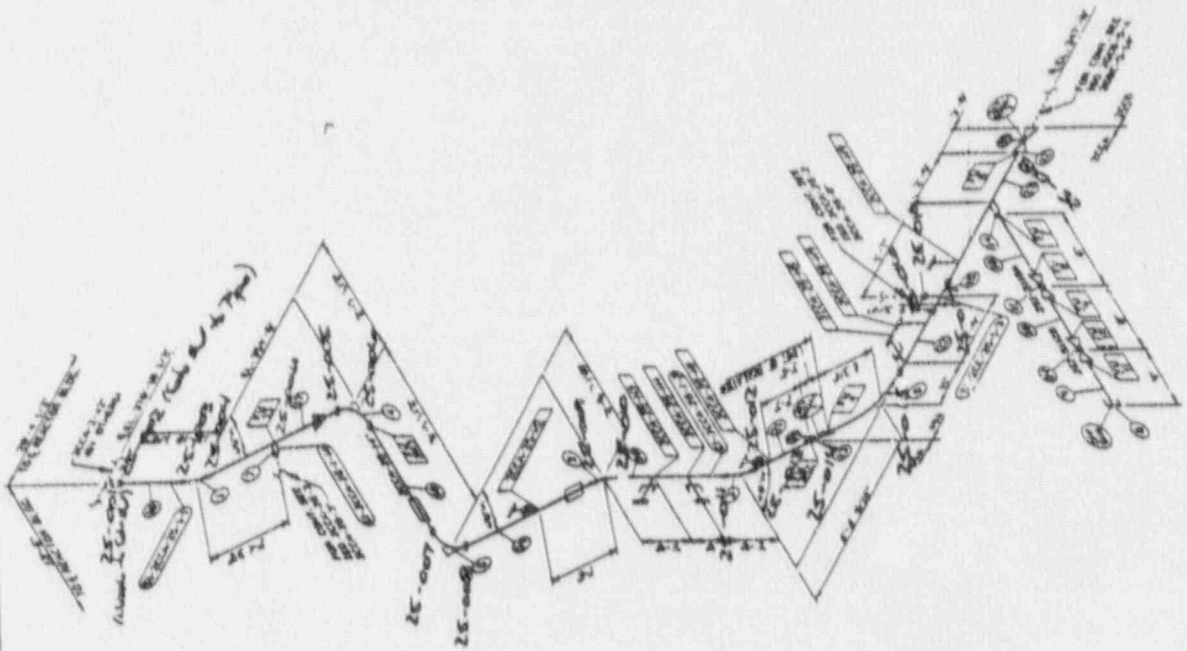

BILL OF MATERIALS



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3	PIPE 24" DIA. S. G. 100 FT.	1	FT.	
4	PIPE 24" DIA. S. G. 100 FT.	1	FT.	
5	PIPE 24" DIA. S. G. 100 FT.	1	FT.	
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81	PIPE 24" DIA. S. G. 100 FT.	1	FT.	
82	PIPE 24" DIA. S. G. 100 FT.	1	FT.	
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86	PIPE 24" DIA. S. G. 100 FT.	1	FT.	
87	PIPE 24" DIA. S. G. 100 FT.	1	FT.	
88	PIPE 24" DIA. S. G. 100 FT.	1	FT.	
89	PIPE 24" DIA. S. G. 100 FT.	1	FT.	
90	PIPE 24" DIA. S. G. 100 FT.	1	FT.	
91	PIPE 24" DIA. S. G. 100 FT.	1	FT.	
92	PIPE 24" DIA. S. G. 100 FT.	1	FT.	
93	PIPE 24" DIA. S. G. 100 FT.	1	FT.	
94	PIPE 24" DIA. S. G. 100 FT.	1	FT.	
95	PIPE 24" DIA. S. G. 100 FT.	1	FT.	
96	PIPE 24" DIA. S. G. 100 FT.	1	FT.	
97	PIPE 24" DIA. S. G. 100 FT.	1	FT.	
98	PIPE 24" DIA. S. G. 100 FT.	1	FT.	
99	PIPE 24" DIA. S. G. 100 FT.	1	FT.	
100	PIPE 24" DIA. S. G. 100 FT.	1	FT.	

NOTE: SLIPPING INDICATED AS SHOWN.

<p>REFERENCE</p> <p>P. &amp; M. 24" DIA. S. G. 100 FT.</p> <p>AREA 24" DIA. S. G. 100 FT.</p> <p>BLDG. REACTOR S. G. 100 FT.</p> <p>SYSTEM SAFETY INJECTION SYSTEM</p> <p>DESIGNER: ARKANSAS POWER AND LIGHT COMPANY</p> <p>DATE: 10/10/68</p> <p>PROJECT: 24" DIA. S. G. 100 FT.</p>	<p> <table border="1"> <tr><td>NO.</td><td>REV.</td><td>DATE</td><td>DESCRIPTION</td></tr> <tr><td>1</td><td></td><td></td><td></td></tr> <tr><td>2</td><td></td><td></td><td></td></tr> <tr><td>3</td><td></td><td></td><td></td></tr> <tr><td>4</td><td></td><td></td><td></td></tr> <tr><td>5</td><td></td><td></td><td></td></tr> <tr><td>6</td><td></td><td></td><td></td></tr> <tr><td>7</td><td></td><td></td><td></td></tr> <tr><td>8</td><td></td><td></td><td></td></tr> <tr><td>9</td><td></td><td></td><td></td></tr> <tr><td>10</td><td></td><td></td><td></td></tr> </table> </p>	NO.	REV.	DATE	DESCRIPTION	1				2				3				4				5				6				7				8				9				10																																															
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<p>SYSTEM CLEANING METHOD:</p> <p>WATER</p> <p>2000 P.S.I. 300 F.</p> <p>2000 P.S.I. 600 F.</p> <p>STARTUP AND SHUT DOWN</p> <p>ISOLATION CLASSIFICATION</p> <p>REVISIONS: 1, 2, 3, 99, 100</p>	<p> <table border="1"> <tr><td>NO.</td><td>REV.</td><td>DATE</td><td>DESCRIPTION</td></tr> <tr><td>1</td><td></td><td></td><td></td></tr> <tr><td>2</td><td></td><td></td><td></td></tr> <tr><td>3</td><td></td><td></td><td></td></tr> <tr><td>4</td><td></td><td></td><td></td></tr> <tr><td>5</td><td></td><td></td><td></td></tr> <tr><td>6</td><td></td><td></td><td></td></tr> <tr><td>7</td><td></td><td></td><td></td></tr> <tr><td>8</td><td></td><td></td><td></td></tr> <tr><td>9</td><td></td><td></td><td></td></tr> <tr><td>10</td><td></td><td></td><td></td></tr> </table> </p>	NO.	REV.	DATE	DESCRIPTION	1				2				3				4				5				6				7				8				9				10																																															
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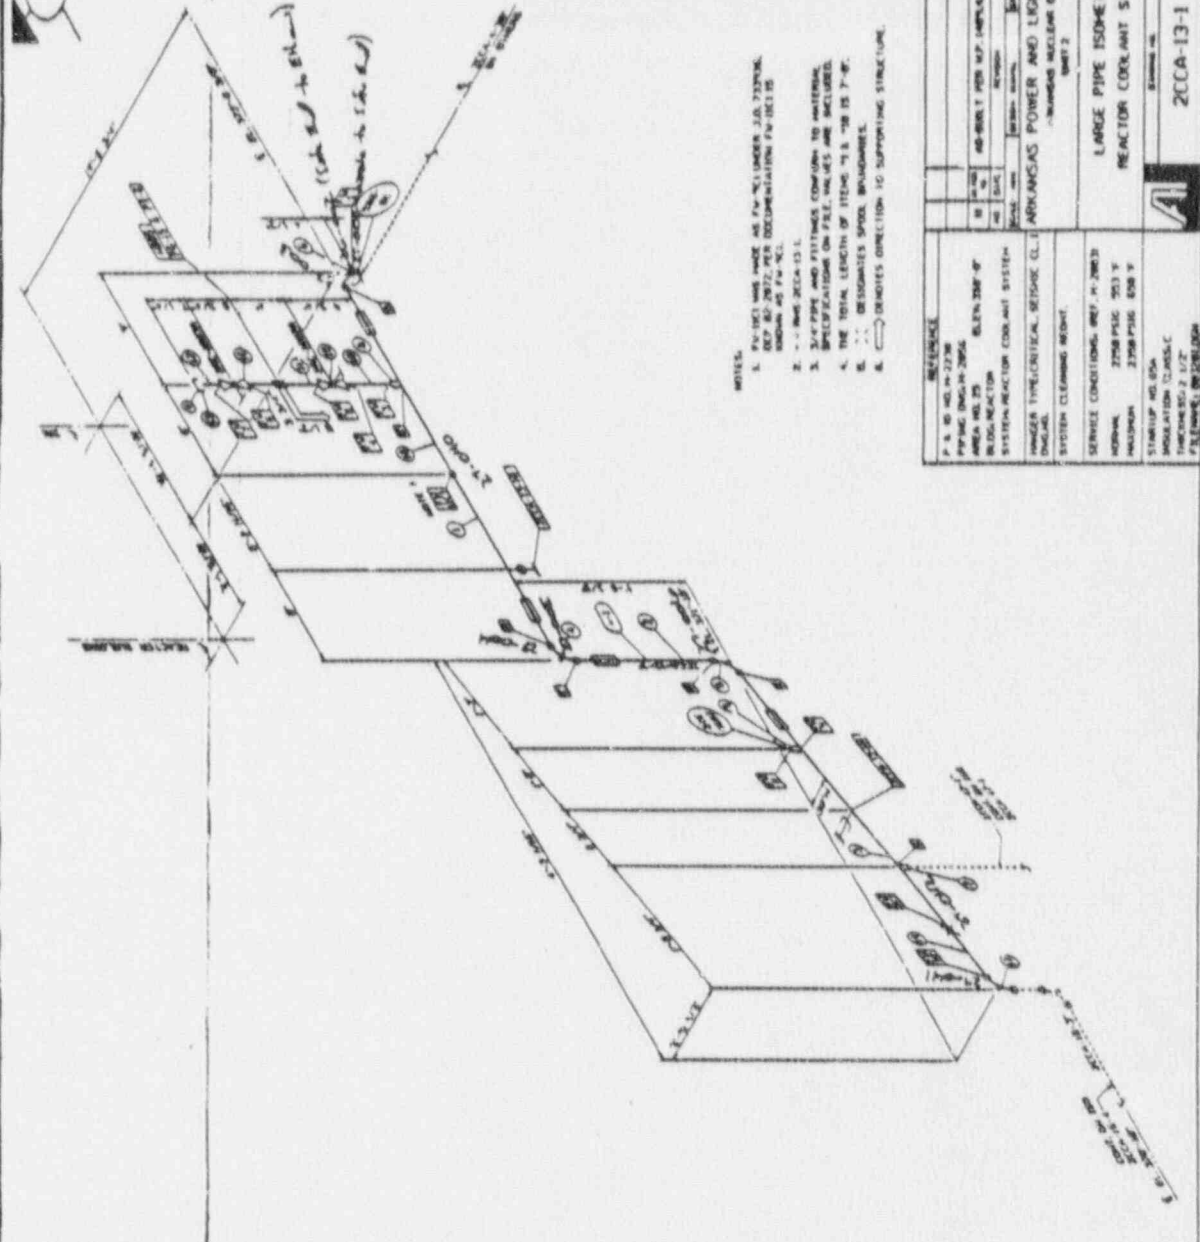
REFERENCE	PBID 1. M-2230 PIPING DWG. M-2057 AREA NO. 205 ELEV. BLOG REACTOR BUILDING SYS. SAFETY INJECTION SYSTEM		
NO.	DATE	REVISION	BY
1			
2			
SCALE: NONE			
DRAWN BY: [Signature]			
CHECKED BY: [Signature]			
APPROVED BY: [Signature]			
PROJECT: ARKANSAS POWER AND LIGHT COMPANY UNIT 2 ARKLA 75AS NUCLEAR ONE			
TITLE: LARGE PIPE ISOMETRIC SAFETY INJECTION SYSTEM			
DRAWING NO. 2008-71-3			
REV. 9			

ITEM	QTY	DESCRIPTION	HEAT NO.	ASTM	GRD	STARTUP NO.	INSULATION CLASS	THICK.
1	2	1" 6000# TDS CAP						
2	1	1" 6000# TDS VALVE						
3	1	1" 6000# TDS VALVE						
4	1	1" 6000# TDS VALVE						
5	1	1" 6000# TDS VALVE						
6	1	1" 6000# TDS VALVE						
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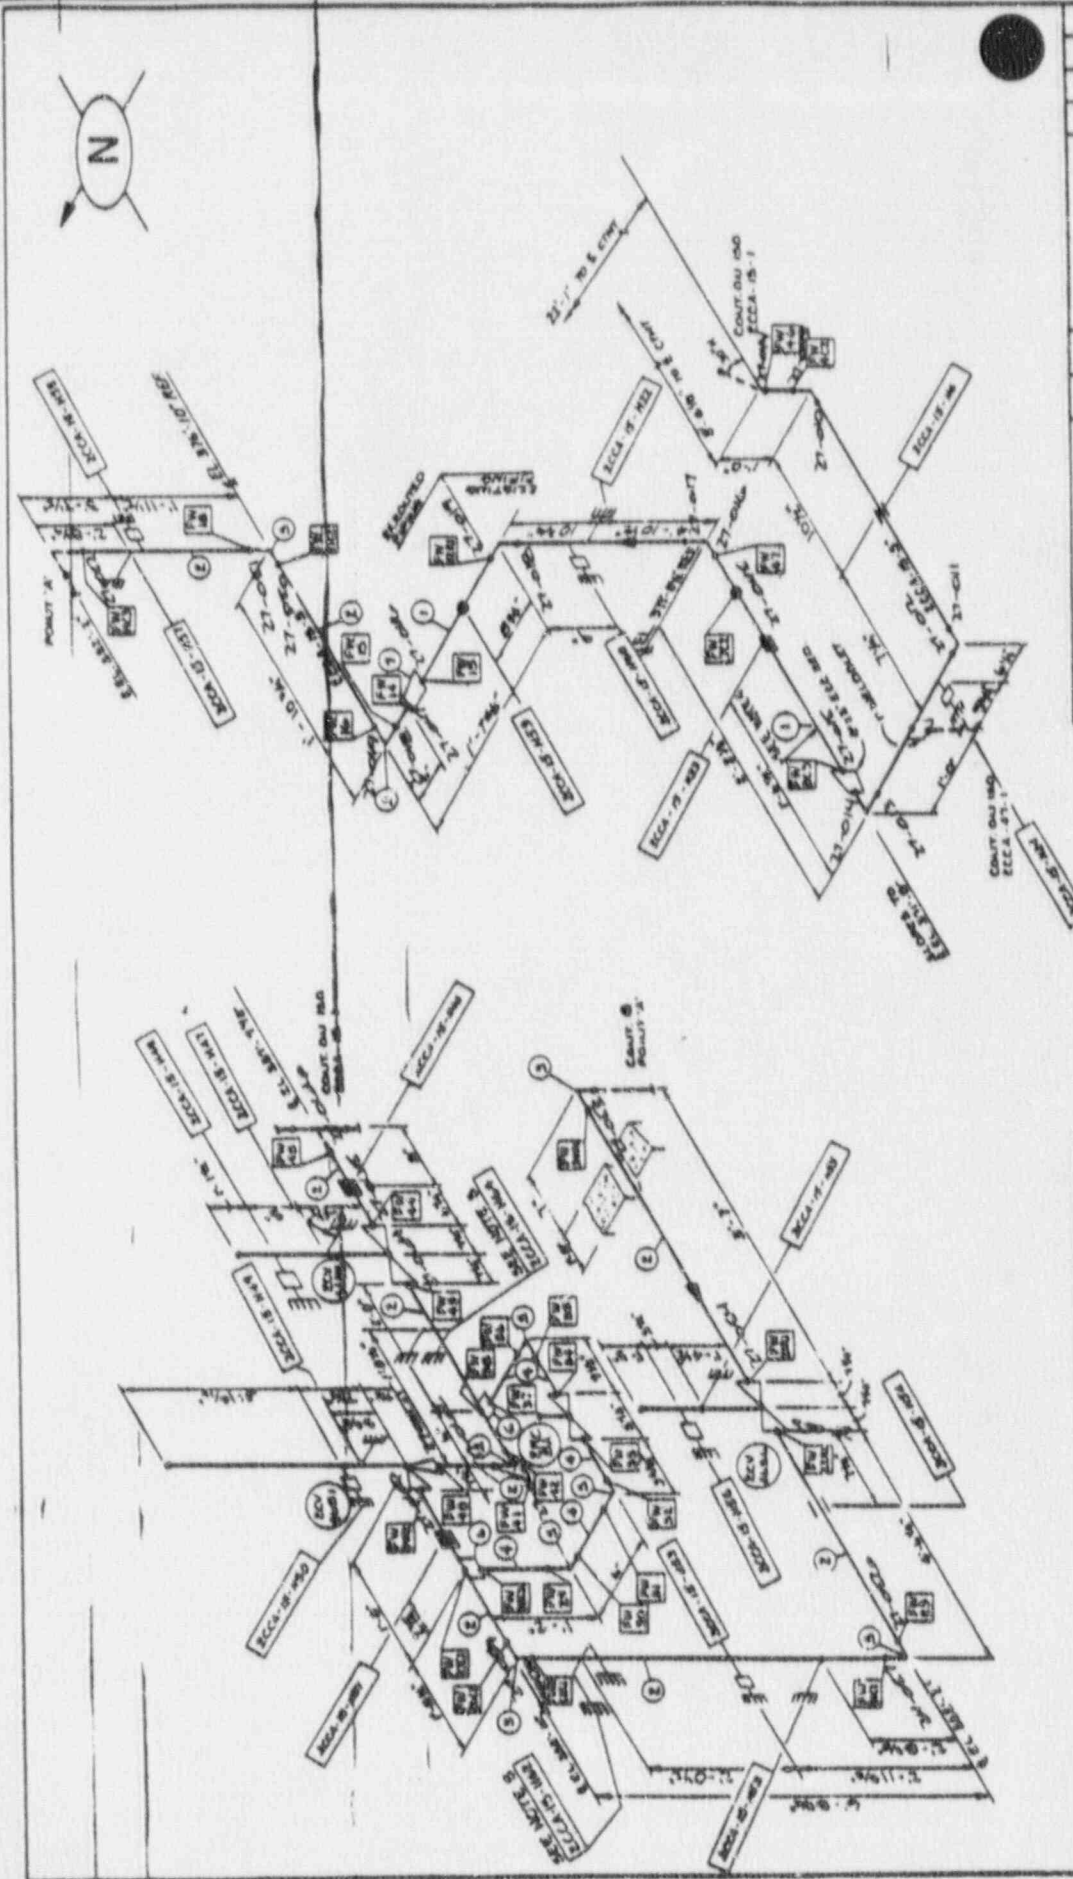


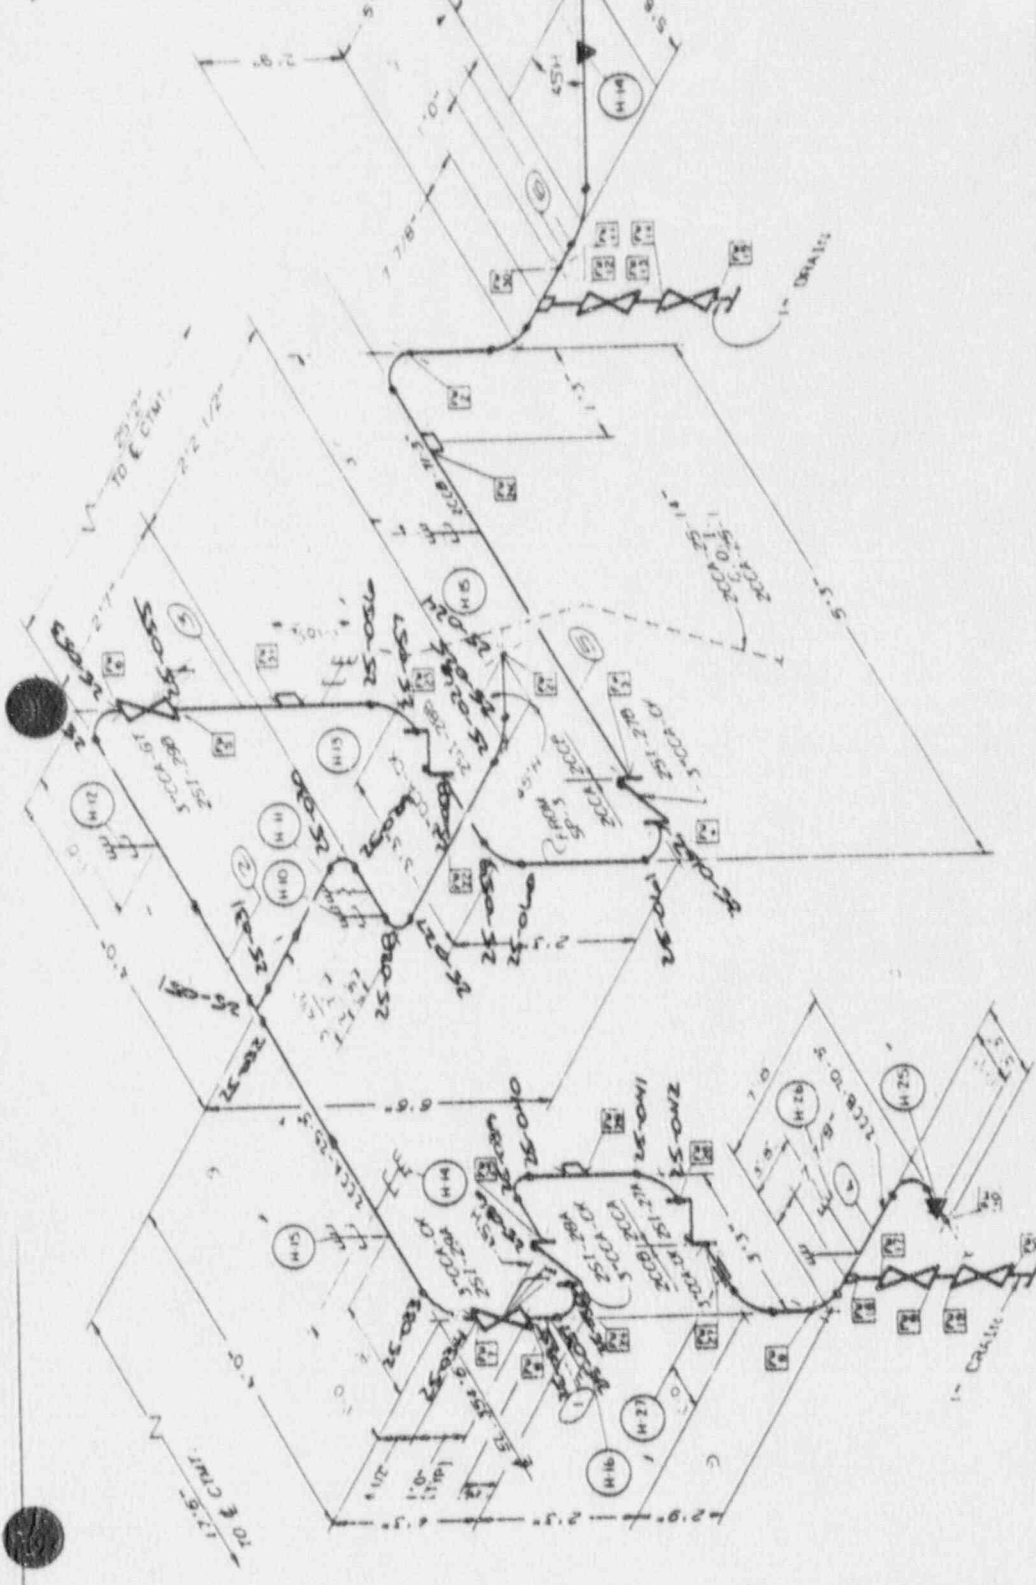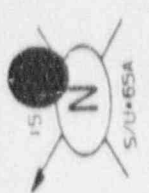

- NOTES:
1. PIPING WAS MADE AS PER UNDER J.A. 73270K. SEE J.A. 73270K FOR OCCUPATION PIPING.
  2. SEE AREA 13.1.
  3. ALL PIPING AND FITTINGS CONFORM TO MATERIAL SPECIFICATIONS ON FILE UNDER AREA 13.1.
  4. THE TOTAL LENGTH OF STEEL IS 108 IS 7'-6".
  5. ... DESIGNATES SPIRAL BRACKET.
  6. ... DENOTES DIRECTION TO SUPPORTING STRUCTURE.

REFERENCE: P. 4. 10. 14. 2270K PIPING DIAGRAM 2005L AREA 13.1 BLEND REACTOR SYSTEM REACTOR COOLANT SYSTEM SINGLE TYPE CRITICAL, REACTOR (L)		ARKANSAS POWER AND LIGHT COMPANY -BANDON NUCLEAR ONE UNIT 2	
SYSTEM CLEANING REPORT SERVICE CONDITIONS: REF. P. 2005L NORMAL: 2300 PSIG 503 °F HOLDUP: 2300 PSIG 503 °F STARTUP: 40.0% MODULATION: 12.5% PIPING: 2.127 7.3. (MATERIAL: 304/316)		LARGE PIPE ISOSHETRIC REACTOR COOLANT SYSTEM DRAWING NO. 200A-13-1 SHEET 11	

BILL OF MATERIALS	
ITEM NO.	DESCRIPTION
1	STEEL PIPE 108 IS 7'-6"
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FIELD NO. WEISDO	DATE	BY	SCALE
PIPING DWG.	ISSUED AS PART OF SET OF	REVISED BY	
AREA NO. 25	ELEV.		
BLDG. CONTAINMENT			
SYS. REACTOR MISC			
NUMBER TYPE			
DWG. NO.			
SYS. CLEANING REPORT			
NO. E-105/B			
SERVICE CONDITIONS			
NORMAL	PSIG	555	°F
MAXIMUM	PSIG	500	°F

3 BULK SHEETS FOR RELEASANTS  
 4 FIELD TO BULK SHEETS 8-1/2 x 11 IN. AND  
 5 RELEASANTS SHEETS 8-1/2 x 11 IN. AND  
 6 THIS DRAWING INCLUDES PIPING FOR RELEASANTS  
 7 DRAWING TOL. IS ±.001 IN.  
 8 SCHEDULE 40 PIPE FOR RELEASANTS  
 9 BILL OF MATERIALS FOR RELEASANTS  
 10 PIPING ONLY

ITEM	QTY	DESCRIPTION	HEAT NO.	ASTM	END
1	1	1/2" SCH. 40 PIPE		A106	
2	1	1/2" SCH. 40 PIPE		A106	
3	1	1/2" SCH. 40 PIPE		A106	
4	1	1/2" SCH. 40 PIPE		A106	
5	1	1/2" SCH. 40 PIPE		A106	
6	1	1/2" SCH. 40 PIPE		A106	
7	1	1/2" SCH. 40 PIPE		A106	
8	1	1/2" SCH. 40 PIPE		A106	
9	1	1/2" SCH. 40 PIPE		A106	
10	1	1/2" SCH. 40 PIPE		A106	
11	1	1/2" SCH. 40 PIPE		A106	
12	1	1/2" SCH. 40 PIPE		A106	
13	1	1/2" SCH. 40 PIPE		A106	
14	1	1/2" SCH. 40 PIPE		A106	
15	1	1/2" SCH. 40 PIPE		A106	
16	1	1/2" SCH. 40 PIPE		A106	
17	1	1/2" SCH. 40 PIPE		A106	
18	1	1/2" SCH. 40 PIPE		A106	
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35	1	1/2" SCH. 40 PIPE		A106	
36	1	1/2" SCH. 40 PIPE		A106	
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39	1	1/2" SCH. 40 PIPE		A106	
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41	1	1/2" SCH. 40 PIPE		A106	
42	1	1/2" SCH. 40 PIPE		A106	
43	1	1/2" SCH. 40 PIPE		A106	
44	1	1/2" SCH. 40 PIPE		A106	
45	1	1/2" SCH. 40 PIPE		A106	
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49	1	1/2" SCH. 40 PIPE		A106	
50	1	1/2" SCH. 40 PIPE		A106	











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CONTAINMENT

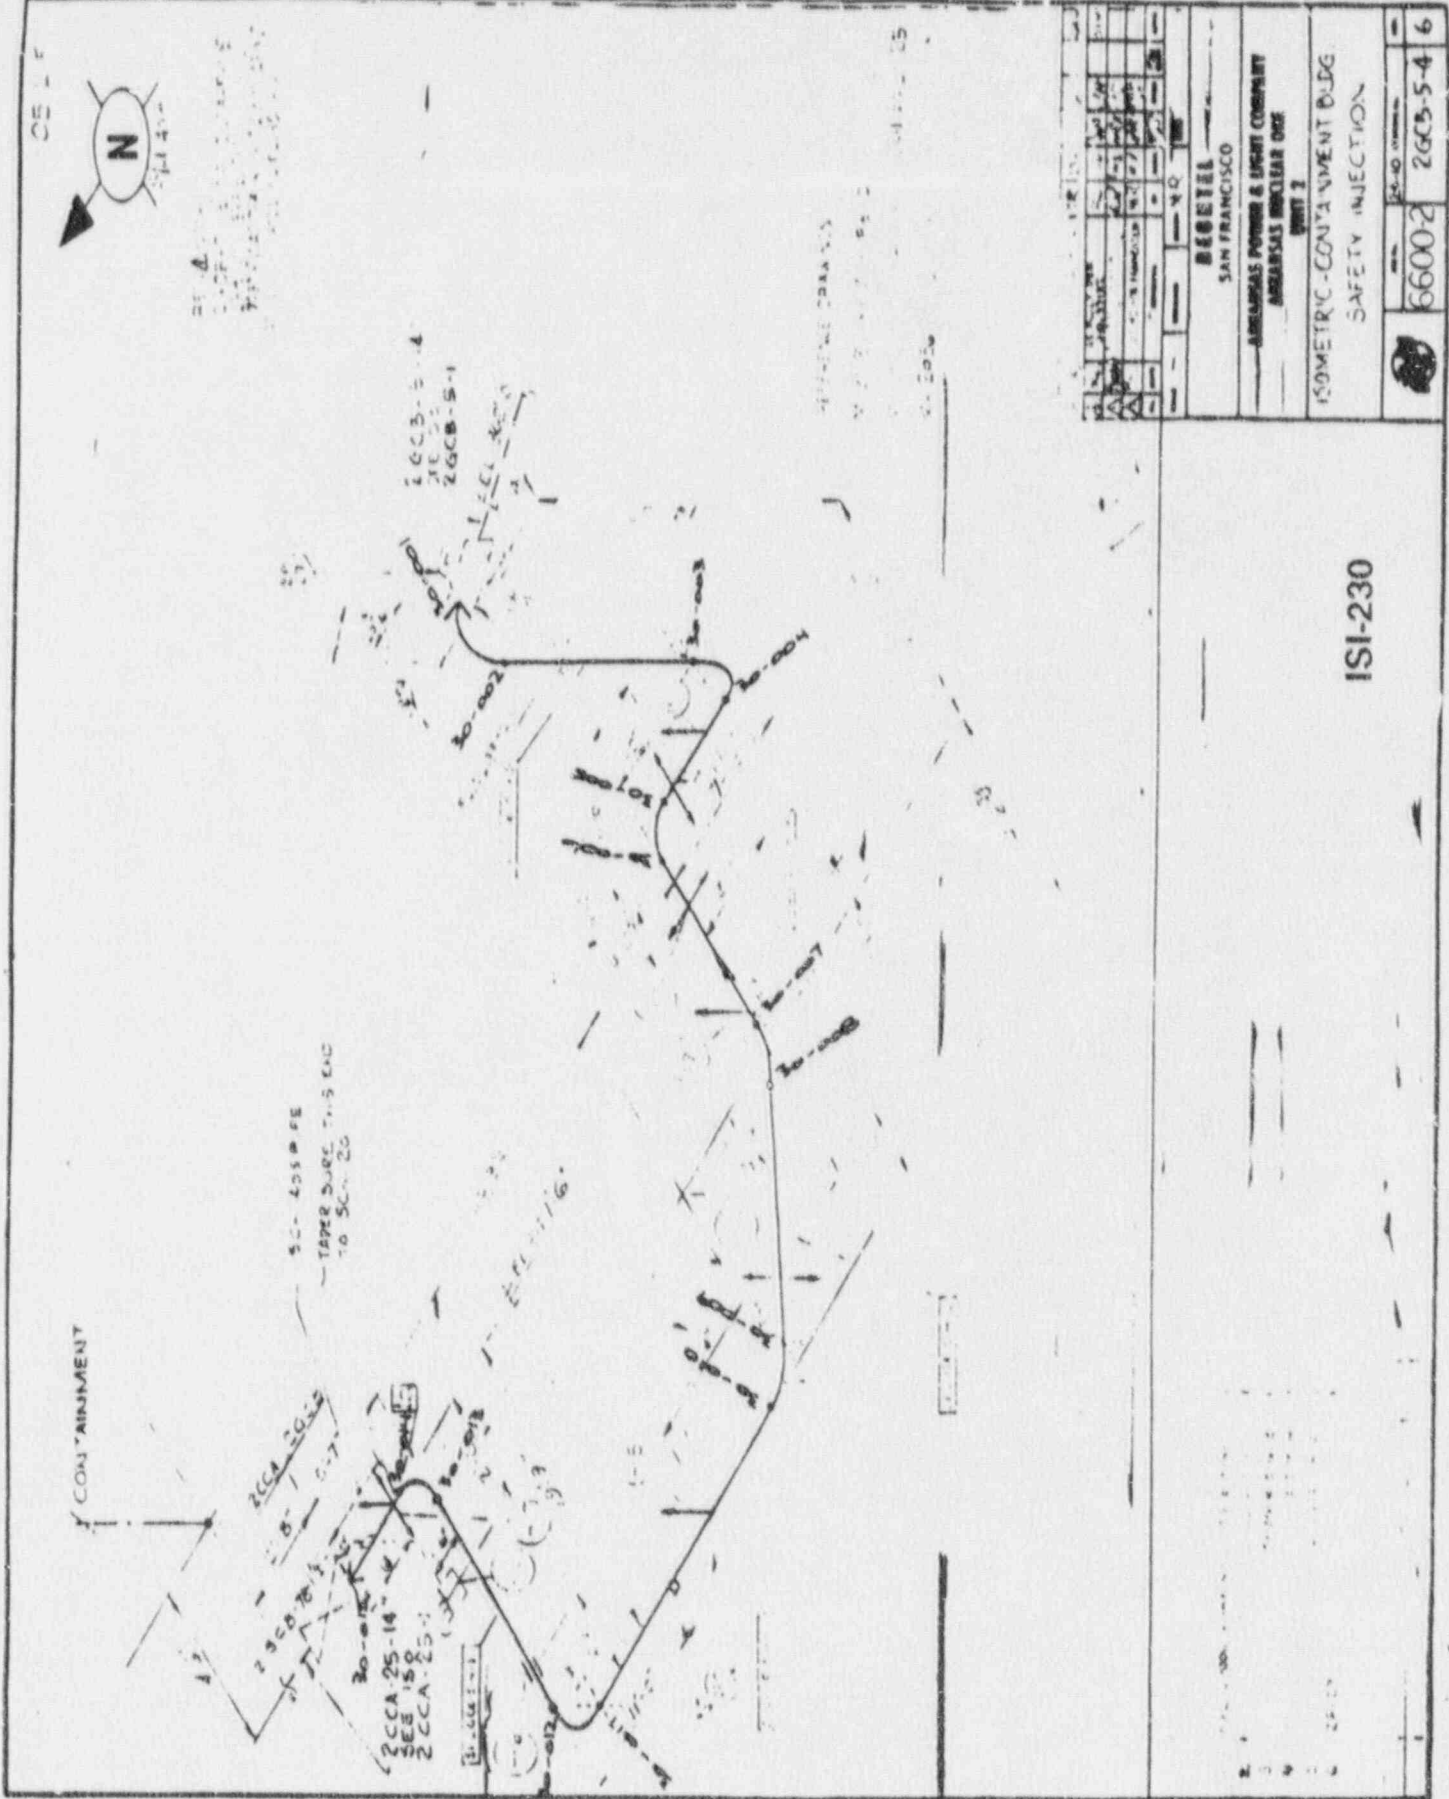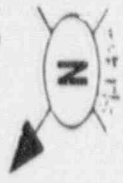50-405# FE  
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TO SC-20

2CCA-25-14  
SEE ISO  
2CCA-25-15


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2CCB-5-2  
2CCB-5-3  
2CCB-5-4

ISI-230

BEEHIVE SAN FRANCISCO	
ARMSTRONG POWER & LIGHT COMPANY ARMSTRONG NUCLEAR ONE UNIT 2	
ISOMETRIC - CONTAINMENT BLDG SAFETY INJECTION	
NO. 66002	2605-5-4-6

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NOTE  
FOR HANGERS INFORMATION SEE  
2CCA-32-10.

"RADIOACTIVE"

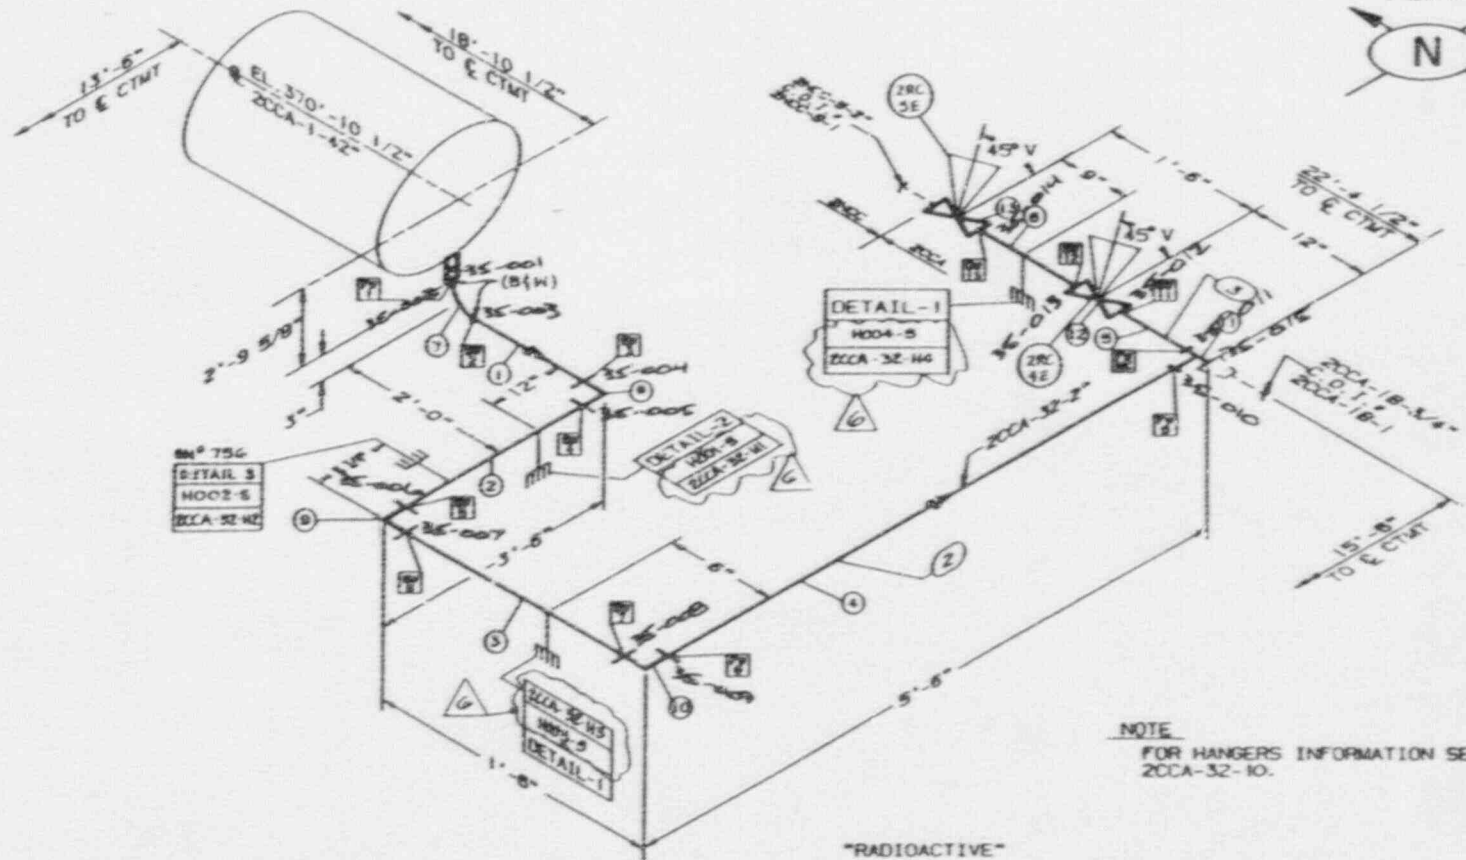ITEM	QTY	DESCRIPTION	HEAT NO.	ASTM	GRD.
13	1	2" 1800# S.W. OCA-BT	S/N 978	WEST	1973
12	1	2" 1800# S.W. OCA-BT	S/N 945	WEST	1973
11	1	2" 8000# S.W. TEE	D.W.	SA-192	F-316
10	1	2" 8000# S.W. 90° ELL	YF	SA-192	F-316
9	1	2" 8000# S.W. 90° ELL	YF	SA-192	F-316
8	1	2" 8000# S.W. 90° ELL	YF	SA-192	F-316
7	1	2" 8000# D.W. 90° ELL	C7159	SA-192	F-316
6	21 F	2" SA.S SCH. 180 PIPE	454389	SA-312	TP-316
5	11 F	2" SA.S SCH. 180 PIPE	454389	SA-312	TP-316
4	6 F	2" SA.S SCH. 180 PIPE	454389	SA-312	TP-316
3	21 F	2" SA.S SCH. 180 PIPE	454389	SA-312	TP-316
2	11 F	2" SA.S SCH. 180 PIPE	454389	SA-312	TP-316
1	21 F	2" SA.S SCH. 180 PIPE	454389	SA-312	TP-316

BILL OF MATERIAL

STARTUP NO. 65A INSULATION CLASS C THICK 2 1/2"

REFERENCE		5	AS-BUILT: DCP 85-260	END	TR	REV
P&ID NO. M-2230		4	AS-BUILT: PEAR 85-1000	TR	FW	L CAN
PUMPING DIAG. M-2808		G	AS-BUILT: PEAR 85-0322	TR	FW	L CAN
AREA NO. 25 ELEV. 757'-0"						
BLDG. REACTOR BLDG.						
SYS. REACTOR COOLANT DRAIN						
NO.	DATE	REVISION	BY			
SCALE	NONE	DRAWN	BECHTEL	DRAWN	DOWELL	
ARKANSAS POWER AND LIGHT COMPANY						
ARKANSAS NUCLEAR ONE						
UNIT 2						
SMALL PIPE ISOMETRIC						
REACTOR COOLANT DRAIN SYSTEM						
SERVICE CONDITIONS						
NORMAL	2250	PSI	8.11			
MAXIMUM	2300	PSI	8.50			
DRAWING NO.		2CCA-32-1				
REV.		6				


















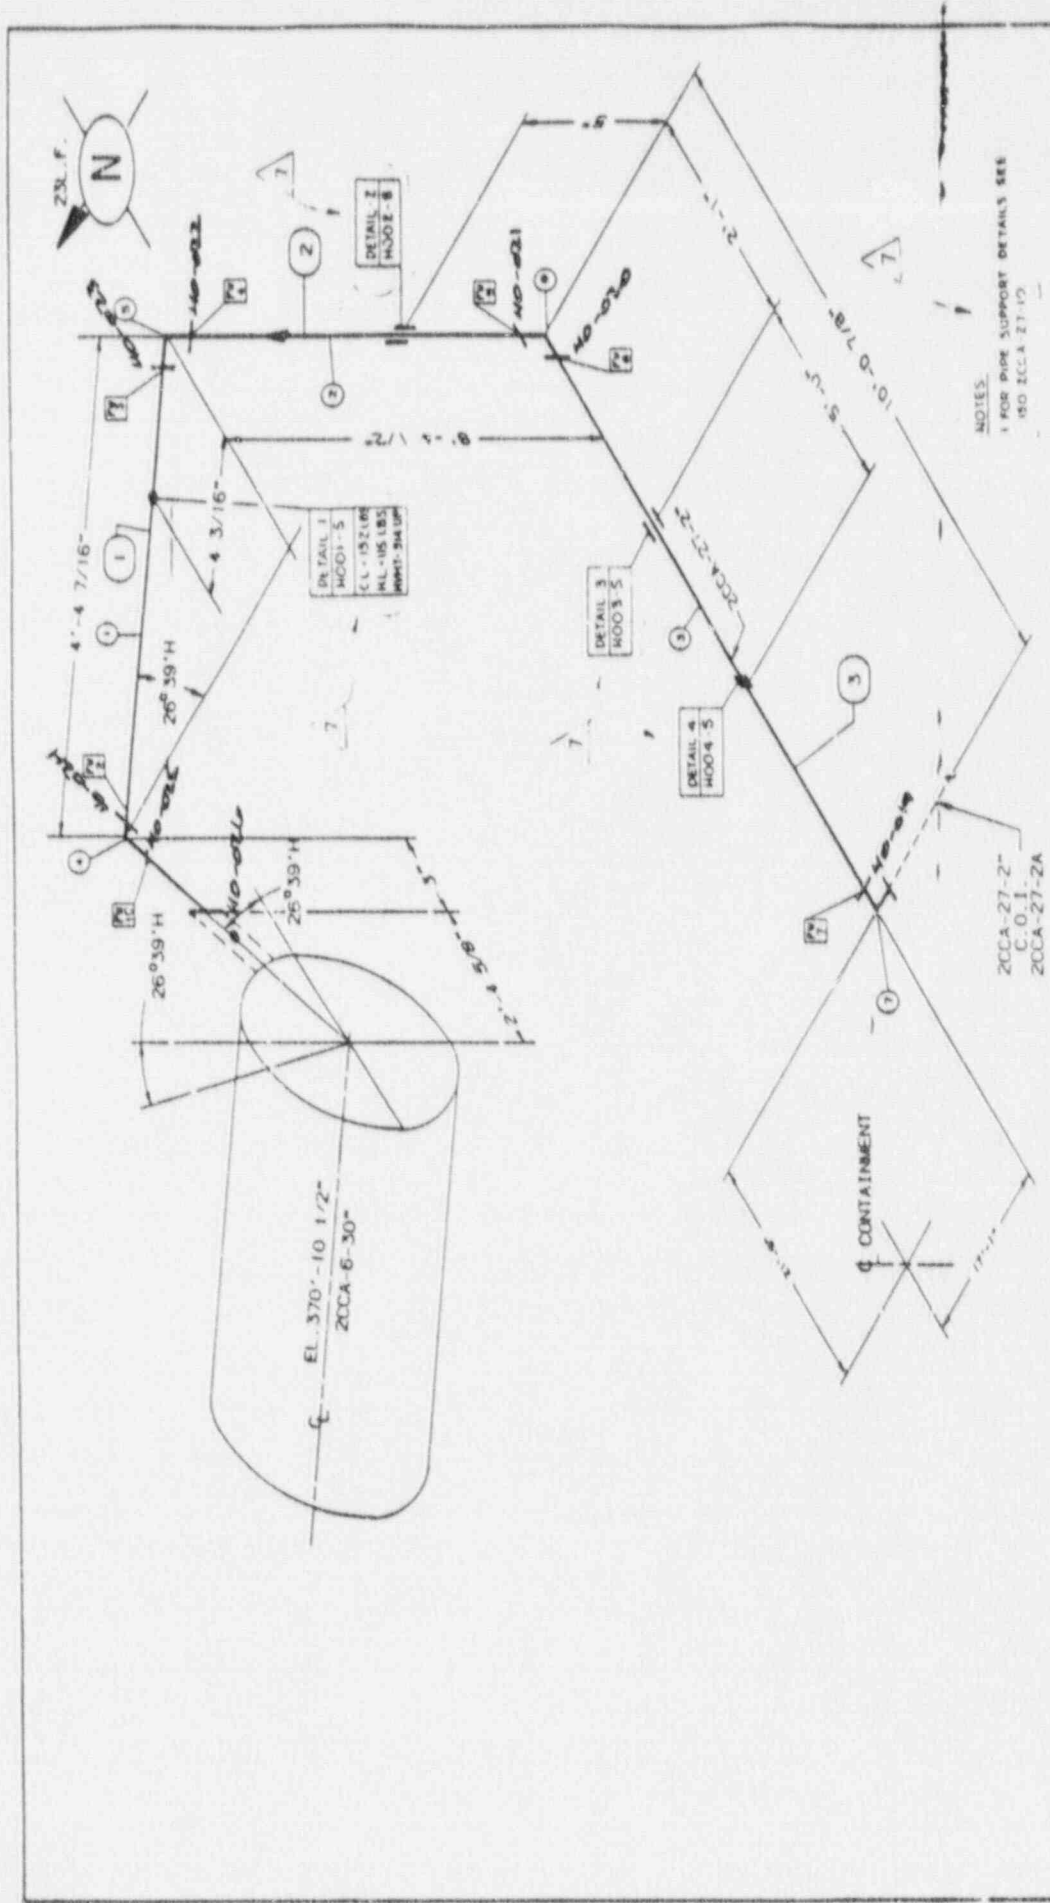

NO	DATE	REVISION	BY	CHKD BY	72
1					
2					
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REFERENCE	
P&ID NO	M-2230
PIPING DRG	M-2096 & M-2097
AREA NO	Z5
BLDG	REACTOR BUILDING
SYS	REACTOR COOLANT SYSTEM
HANGER TYPE NEX. SEIS. CL. 1(H)	
DRG NO	M-2806 11/RU -10
SYS CLEANING RDMT	
DRG NO	M-2237
SERVICE CONDITIONS	
NORMAL	2250 PSIG 200 °F
MAXIMUM	2350 PSIG 200 °F


ARIZONA POWER AND LIGHT COMPANY ARKANSAS NUCLEAR ONE UNIT 2	
SMALL PIPE ISOMETRIC REACTOR COOLANT SYSTEM	
AP	
20CA-27-1	

ITEM	QTY	DESCRIPTION	HEAT NO	ASTM	DRG
7	1	3" 6000# BR 509 ELL SA 403	C-7149		WP 316
8	1	3" 6000# BR 509 ELL SA 403	C-7145		WP 316
9	1	3" 6000# BR 509 ELL SA 403	C-7145		WP 316
10	1	3" 6000# BR 509 ELL SA 403	C-7145		WP 316
11	10 LF	3" 6000# BR 509 ELL SA 403	486979		TP 316
12	9 LF	3" 6000# BR 509 ELL SA 403	245416		TP 316
13	8 LF	3" 6000# BR 509 ELL SA 403	486979		TP 316

STARTUP NO 05A INDICATION CLASS C THICK 2 UZ

NOTES:  
1 FOR PIPE SUPPORT DETAILS SEE  
ISO ECCA 27-10

33 L.F.

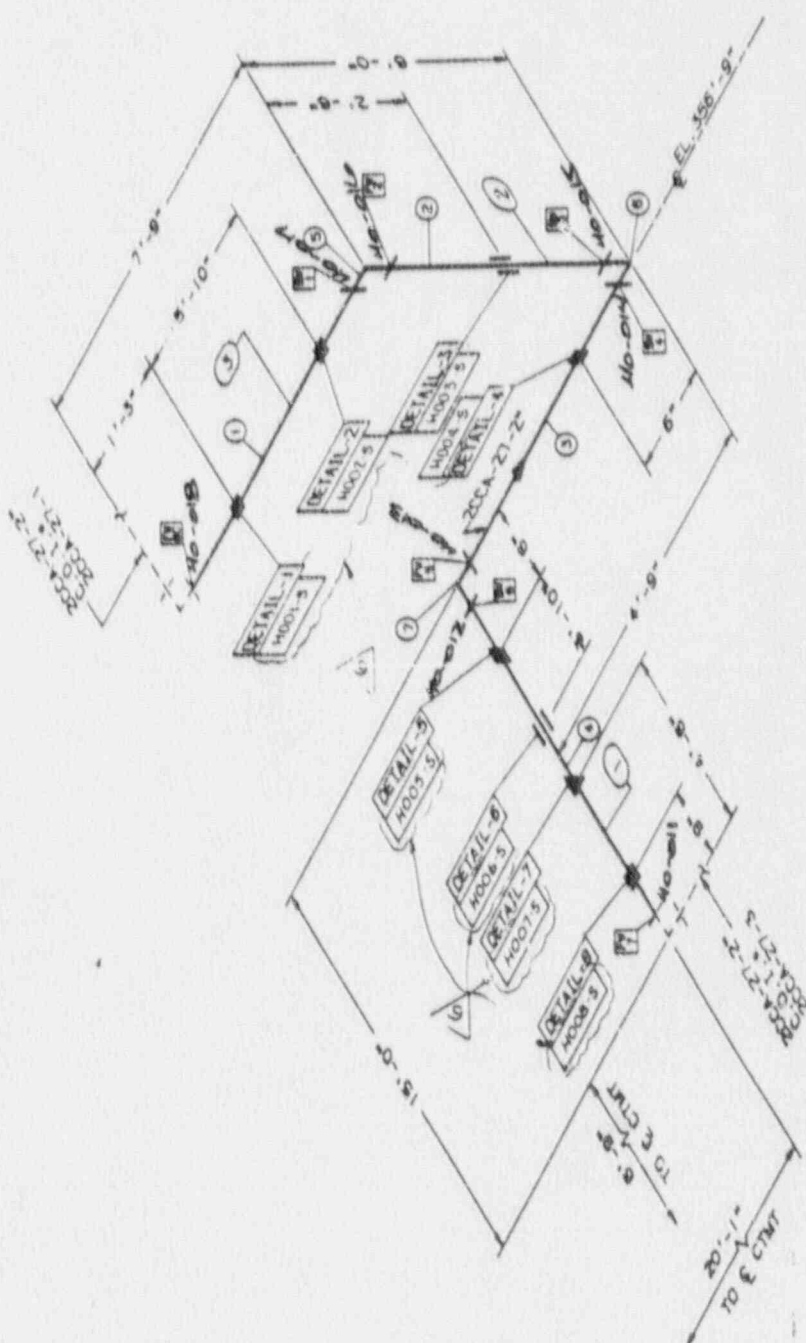


NOTES:  
 1 FOR PIPE SUPPORT DETAILS SEE  
 ISO DCCA-27-11 & DCCA-27-12

RADIOACTIVE NO. SHIELDING REQU'D.

REFERENCE	P.B.I.D. NO. M-2230 & M-2231, SHT. 1 PIPING Dwg. M-2050 & M-2057 AREA NO. 25 ELEV. 3.05'-8" BLDG. REACTOR BLDG. SYS. CHEMICAL VOLUME CONTROL	SCALE: AS SHOWN	DATE: 10/1/54	DESIGNED BY: [Signature]	CHECKED BY: [Signature]
PROJECT	ARKANSAS POWER AND LIGHT COMPANY ARKANSAS NUCLEAR ONE UNIT 2	SMALL PIPE ISOMETRIC CHEMICAL VOLUME CONTROL SYSTEM			
STARTUP NO. 858	ISOLATION CLASS C THICK 2.12'	MATERIAL: 2250 PPM 200' DIA 2350 PPM 450' DIA			

ITEM	QTY	DESCRIPTION	WEIGHT NO.	ASTM	END
1	1	2" SCH 40S 180 PIPE	C-7118	SA-403 WP 316	
2	1	2" SCH 40S 180 PIPE	C-7118	SA-403 WP 316	
3	1	2" SCH 40S 180 PIPE	C-7118	SA-403 WP 316	
4	1	2" SCH 40S 180 PIPE	435921	SA-512 WP 316	
5	1	2" SCH 40S 180 PIPE	430079	SA-512 WP 316	
6	1	2" SCH 40S 180 PIPE	480678	SA-512 WP 316	
7	1	2" SCH 40S 180 PIPE	308618	SA-512 WP 316	

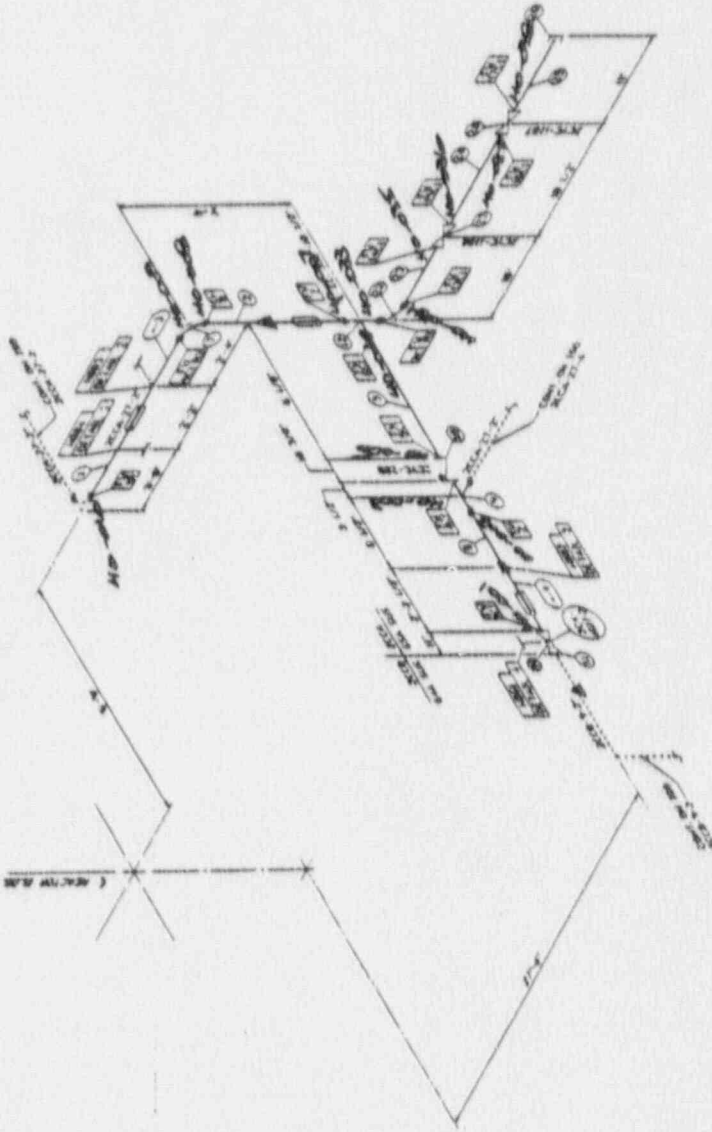

REFERENCE	P. A. 22	NO. 2739	NO. 1
DATE	NOV. 1956	NO. 2737	NO. 1
DESIGNER	ARIZONA STATE COLLEGE	NO. 2738	NO. 1
ENGINEER	ARIZONA STATE COLLEGE	NO. 2739	NO. 1
PROJECT	ARIZONA STATE COLLEGE	NO. 2740	NO. 1
LOCATION	ARIZONA STATE COLLEGE	NO. 2741	NO. 1
SCALE	AS SHOWN	NO. 2742	NO. 1
REVISIONS		NO. 2743	NO. 1
NO.	DATE	BY	REASON
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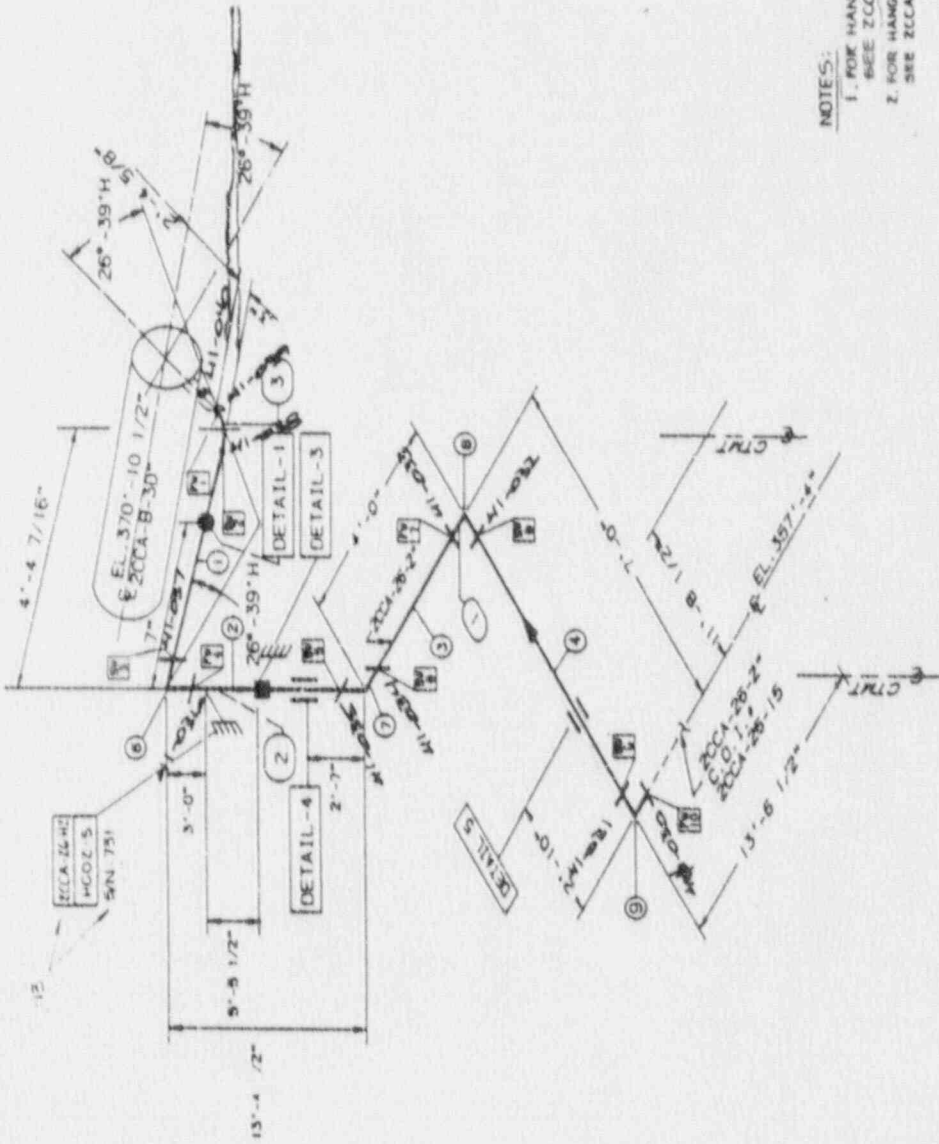
NOTES:  
 1. FOR PIPE SUPPORTS SEE ENG. Dwg. 2734.  
 2. SEE 2733.  
 3. AUTOMATIC AND SHIELDING REQUIRED.







29 L.F.



NOTES:  
 1. FOR HANGER DETAILS 1, 2 & 3,  
 SEE ZCCA-26-15.  
 2. FOR HANGER DETAILS 4 & 5,  
 SEE ZCCA-26-11.

ITEM	QTY	DESCRIPTION	HEAT NO	ASTM	GRD
9	1	2" SCH. 160 DW 90° ELL.	SA-403		
10	1	2" SCH. 160 DW 90° ELL.	SA-403		
11	1	2" SCH. 160 DW 90° ELL.	SA-403		
12	1	2" SCH. 160 DW 90° ELL.	SA-403		
13	1	2" SCH. 160 DW 90° ELL.	SA-403		
14	1	2" SCH. 160 DW 90° ELL.	SA-403		
15	1	2" SCH. 160 DW 90° ELL.	SA-403		
16	1	2" SCH. 160 DW 90° ELL.	SA-403		
17	1	2" SCH. 160 DW 90° ELL.	SA-403		
18	1	2" SCH. 160 DW 90° ELL.	SA-403		
19	1	2" SCH. 160 DW 90° ELL.	SA-403		
20	1	2" SCH. 160 DW 90° ELL.	SA-403		
21	1	2" SCH. 160 DW 90° ELL.	SA-403		
22	1	2" SCH. 160 DW 90° ELL.	SA-403		
23	1	2" SCH. 160 DW 90° ELL.	SA-403		
24	1	2" SCH. 160 DW 90° ELL.	SA-403		
25	1	2" SCH. 160 DW 90° ELL.	SA-403		
26	1	2" SCH. 160 DW 90° ELL.	SA-403		
27	1	2" SCH. 160 DW 90° ELL.	SA-403		
28	1	2" SCH. 160 DW 90° ELL.	SA-403		
29	1	2" SCH. 160 DW 90° ELL.	SA-403		
30	1	2" SCH. 160 DW 90° ELL.	SA-403		
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44	1	2" SCH. 160 DW 90° ELL.	SA-403		
45	1	2" SCH. 160 DW 90° ELL.	SA-403		
46	1	2" SCH. 160 DW 90° ELL.	SA-403		
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97	1	2" SCH. 160 DW 90° ELL.	SA-403		
98	1	2" SCH. 160 DW 90° ELL.	SA-403		
99	1	2" SCH. 160 DW 90° ELL.	SA-403		
100	1	2" SCH. 160 DW 90° ELL.	SA-403		

STARTUP NO. 656 INSULATION CLASS. C THICK. 2 1/2"

REV	DATE	BY	CHKD	DESCRIPTION
13	10/18/83	MS	MS	AS BUILT: DCF 85 ZCCG 030/4
12	10/18/83	MS	MS	AS BUILT: T PEAR 03 14 25 72 Pm 3
11	10/18/83	MS	MS	REVISION FOR APPROVED QUALITY
10	10/18/83	MS	MS	REVISION
9	10/18/83	MS	MS	REVISION
8	10/18/83	MS	MS	REVISION
7	10/18/83	MS	MS	REVISION
6	10/18/83	MS	MS	REVISION
5	10/18/83	MS	MS	REVISION
4	10/18/83	MS	MS	REVISION
3	10/18/83	MS	MS	REVISION
2	10/18/83	MS	MS	REVISION
1	10/18/83	MS	MS	REVISION

REFERENCE	SCALE	DATE	BY	CHKD	DESCRIPTION
P-100 NO. M-2230 & M-2231 344.1	AS BUILT	10/18/83	MS	MS	AS BUILT: DCF 85 ZCCG 030/4
P-100 DWS M-2806 & M-2807	AS BUILT	10/18/83	MS	MS	AS BUILT: T PEAR 03 14 25 72 Pm 3
AREA NO 25	AS BUILT	10/18/83	MS	MS	REVISION FOR APPROVED QUALITY
BLDG REACTOR 04306	AS BUILT	10/18/83	MS	MS	REVISION
SYS CHEMICAL & VOLUME CONTROL	AS BUILT	10/18/83	MS	MS	REVISION
HANGER TYPE N.C. SETS O.L. I(H)	AS BUILT	10/18/83	MS	MS	REVISION
DWS NO M-2806 THRU-10	AS BUILT	10/18/83	MS <td MS	REVISION	
SYS CLEANING HEIGHT	AS BUILT	10/18/83	MS	MS	REVISION
M-2237	AS BUILT	10/18/83	MS	MS	REVISION
SERVICE CONDITIONS	AS BUILT	10/18/83	MS	MS	REVISION
NORMAL 2250 PSIG 200 °F	AS BUILT	10/18/83	MS	MS	REVISION
MAXIMUM 2250 PSIG 200 °F	AS BUILT	10/18/83	MS	MS	REVISION

ARKANSAS POWER AND LIGHT COMPANY  
 ARKANSAS NUCLEAR ONE  
 UNIT 2



SMALL PIPE ISOMETRIC  
 CHEMICAL & VOLUME CONTROL SYSTEM

APL  
 ZCCA-26-14  
 13

50LF



NOTE:  
FIELD TO NOTIFY SFMO WHEN BLENDS ARE  
PREPARED IN PLACE OF BUTT WELD JOINTS  
REV. A NOTE:  
KEY TO INCOMP. FIELD AS SHOWN ON  
REV. A NOTED 1-7-77

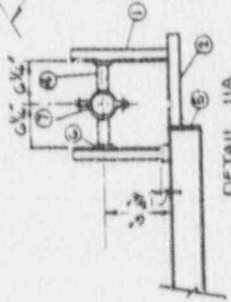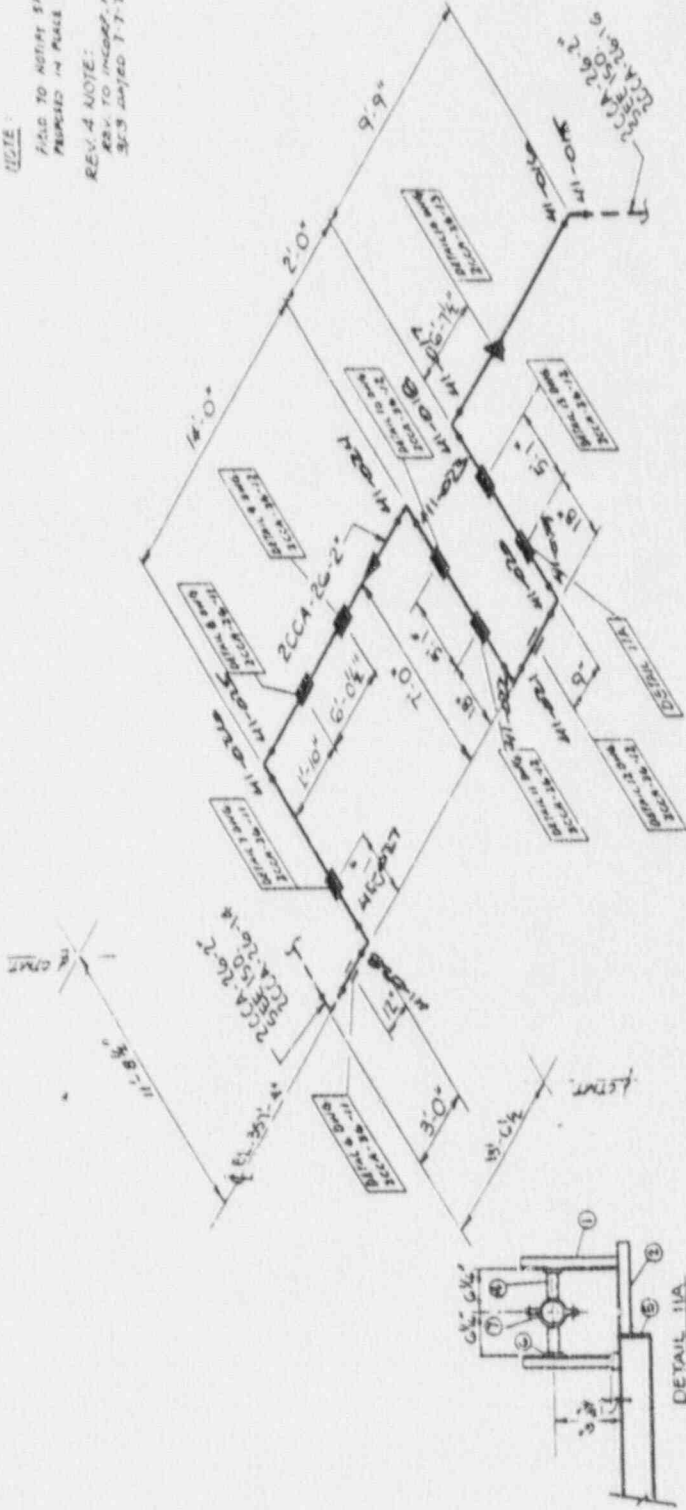

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RADIOACTIVE

8 ALL DIMENSIONS WITHIN 3" FOR CRITICAL NUCLEAR AND SEISMIC 1 AND 6" FOR NON CRITICAL NUCLEAR CAN BE REMOVED WITHOUT SFMO APPROVAL  
7 -- DENOTES DIRECTION TO SUPPORTING  
6 -- STRUCTURE  
5 -- SHOP WELD NO  
4 -- FIELD WELD NO  
3 -- BEND NO  
2 -- STEM NO  
1 -- ITEM NO  
\* DENOTES FIELD FIT UP TO BE WELDED WITH FIELD WELD SYMBOL, SPECIFYING THAT A MIN. OF 8" RANDOM SURVEY SHALL BE LEFT BY FAB. SHOP WELDS SHALL BE MARKED (F) THIS SURPLUS SHALL BE CUT TO FIT BY FIELD

REFERENCE  
P&ID NO. M-2230 P.M.-2231 SART1  
PIPING Dwg. M-2556 P.M.-2557  
AREA NO. 25  
ELEV. 350'-0"  
SYS. CHEMICAL P VOLUME CONTROL  
HANGER TYPE NUC. SEIS. CL. I (P)  
Dwg. NO.  
SYS. CLEANING REPT.  
SERVICE CONDITIONS (REF. M-2083)  
NORMAL 2250 PSIG @ 200°F  
MAXIMUM 2550 PSIG @ 250°F

NO.	REV.	DATE	BY	CHKD.	DESCRIPTION
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4					ISSUED FOR CONSTRUCTION
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50					ISSUED FOR CONSTRUCTION

BECHTEL	
SAN FRANCISCO	
ARKANSAS POWER & LIGHT	
ARKANSAS NUCLEAR ONE	
UNIT 2	
SMALL PIPE BOONTING	
CONTAINMENT BUILDING	
NO.	6600-2
REV.	2CCA-2G-15
DATE	5

ISI-241

I certify that the image contained on this frame was made in the normal and regular course of business, on the date stated below and that it is an accurate reproduction of the document submitted to Micrographics.

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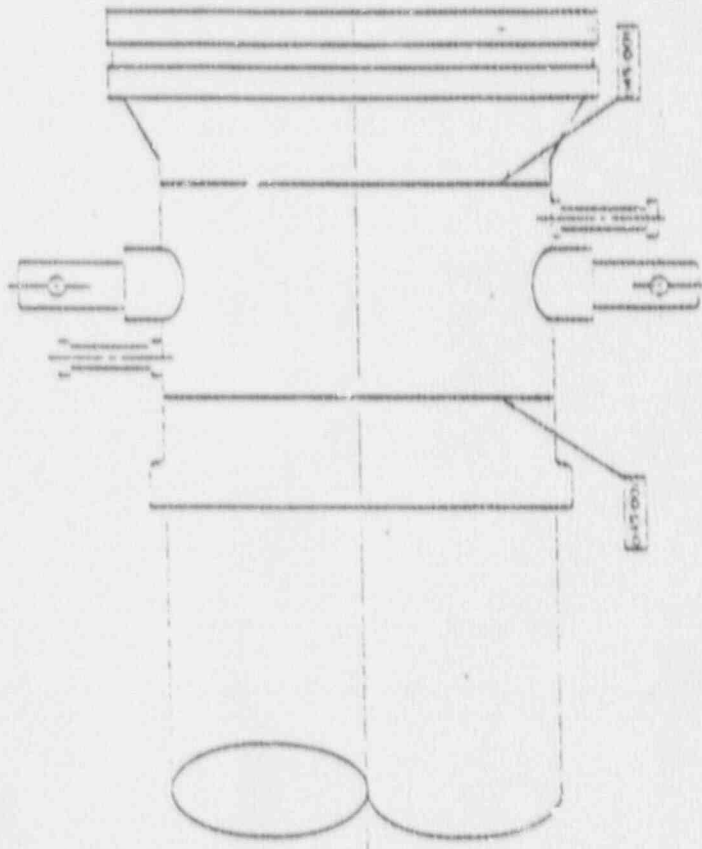












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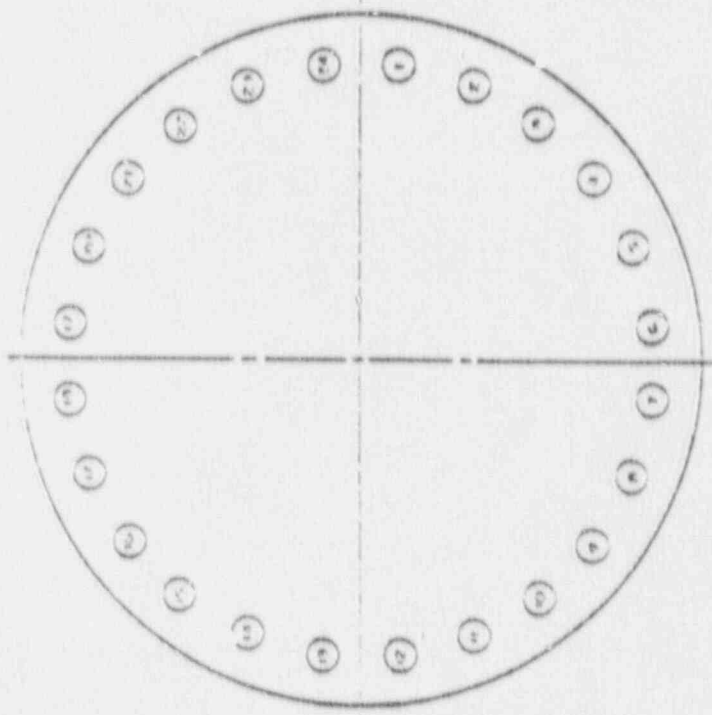
BRASSIER POWER AND LIGHT COMPANY  
BRASSIER NUCLEAR ONE  
UNIT 7

LETDOWN HEAT EXCHANGER  
TUBE SIDE WELD DESIGNATION  
(ZONE 43)

ISSUE NO. 151-243  
REV. 0









BOLTING PATTERN  
TOP VIEW



UNIT 2	
EMERGENCY POWER AND LIGHT COMPENSATION	
ARMYVCS NUCLEAR DIV	
UNIT 2	
LPSI PUMP B	
2P-60B	
(ZONE 47)	
DATE	0
ISSUE NO	151-247

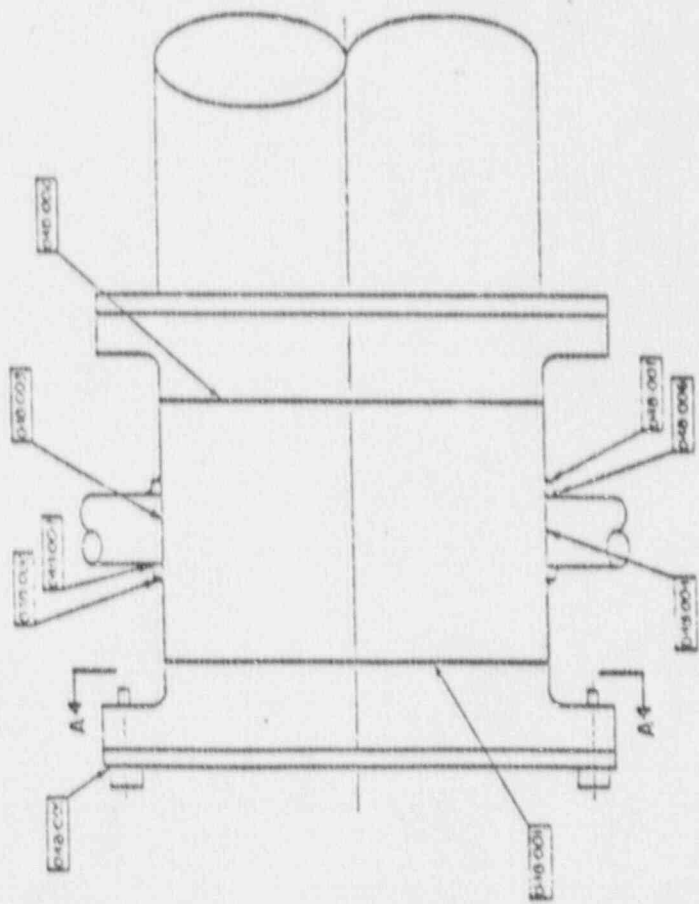

ITEM NO. 2E-35A

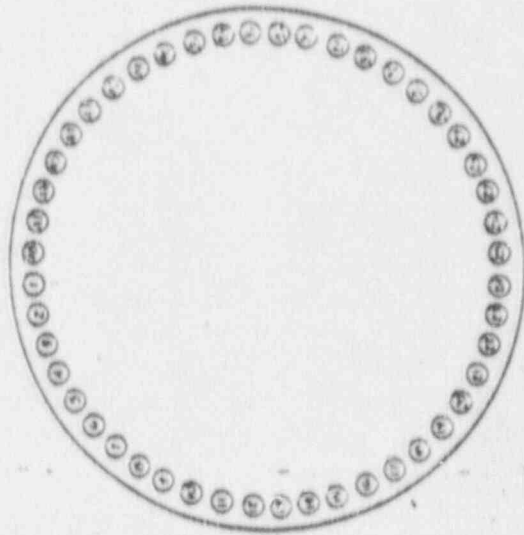

QTY	DESCRIPTION	UNIT	PRICE	TOTAL
1	SHUTDOWN COOLING HEAT EXCHANGER A AREA DESIGNATION (ZONE 49)	EA		
SHUTDOWN COOLING HEAT EXCHANGER A AREA DESIGNATION (ZONE 49) ARCADIS POWER AND LIGHT COMPANY BRANIFFS WHEEL # ONE UNIT 1 DRAWING NO. ISI-248 0				

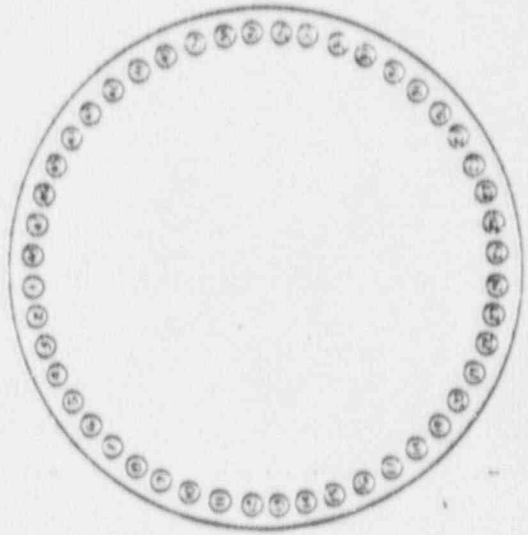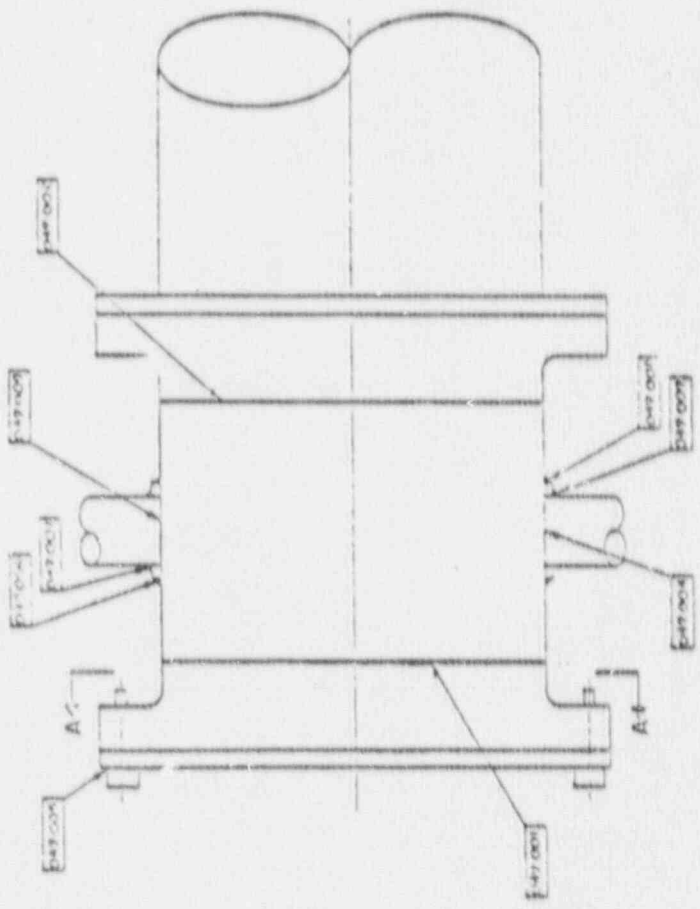

VIEW A-A

REV	DATE	BY	CHKD	APP'D
0	15-8-68	SHADPER 111	7-8	8
ARKANSAS POWER AND LIGHT COMPANY SPRINGFIELD NUCLEAR ONE UNIT 2 SHUTDOWN COOLING HEAT EXCHANGER B AREA DESIGNATIONS (SHEET 43)				
DRAWING NO. ISI-249				REV. 0









REV 2 NOTE: S/U SHD  
 BE FILED IN # 1001-2046 AS FABRICATED BY GUNNELL

REV 3 NOTE:  
 1. ALL DIMENSIONS ARE IN INCHES  
 2. ALL DIMENSIONS ARE TO CENTER UNLESS OTHERWISE SPECIFIED  
 3. ALL DIMENSIONS ARE TO CENTER UNLESS OTHERWISE SPECIFIED  
 4. ALL DIMENSIONS ARE TO CENTER UNLESS OTHERWISE SPECIFIED

REV 5 NOTE:  
 1. ALL DIMENSIONS ARE IN INCHES  
 2. ALL DIMENSIONS ARE TO CENTER UNLESS OTHERWISE SPECIFIED  
 3. ALL DIMENSIONS ARE TO CENTER UNLESS OTHERWISE SPECIFIED  
 4. ALL DIMENSIONS ARE TO CENTER UNLESS OTHERWISE SPECIFIED

NOTE:  
 TEMPORARY STARTUP STRAINERS  
 REMOVED DURING NORMAL OPERATION

REFERENCE DRAWINGS

M-222 RE-23 P410  
 M-2046 RE-12 P410


NO.	DESCRIPTION	QTY	UNIT	REMARKS
1	PIPE SPOOL	1	LINEAL FT	
2	FLANGE	1	EA	
3	WELDING	1	HR	
4	WELDING	1	HR	
5	WELDING	1	HR	
6	WELDING	1	HR	
7	WELDING	1	HR	
8	WELDING	1	HR	
9	WELDING	1	HR	
10	WELDING	1	HR	
11	WELDING	1	HR	
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16	WELDING	1	HR	
17	WELDING	1	HR	
18	WELDING	1	HR	
19	WELDING	1	HR	
20	WELDING	1	HR	
21	WELDING	1	HR	
22	WELDING	1	HR	
23	WELDING	1	HR	
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46	WELDING	1	HR	
47	WELDING	1	HR	
48	WELDING	1	HR	
49	WELDING	1	HR	
50	WELDING	1	HR	

BECHTEL  
 SAN FRANCISCO

AMERICAN POWER & LIGHT COMPANY  
 ANNEBORO NUCLEAR ONE  
 UNIT 2

ISOMET 'C' CONTAINMENT AUX BLEED  
 SAFETY INJECTION

66002 26CB-1-1 10

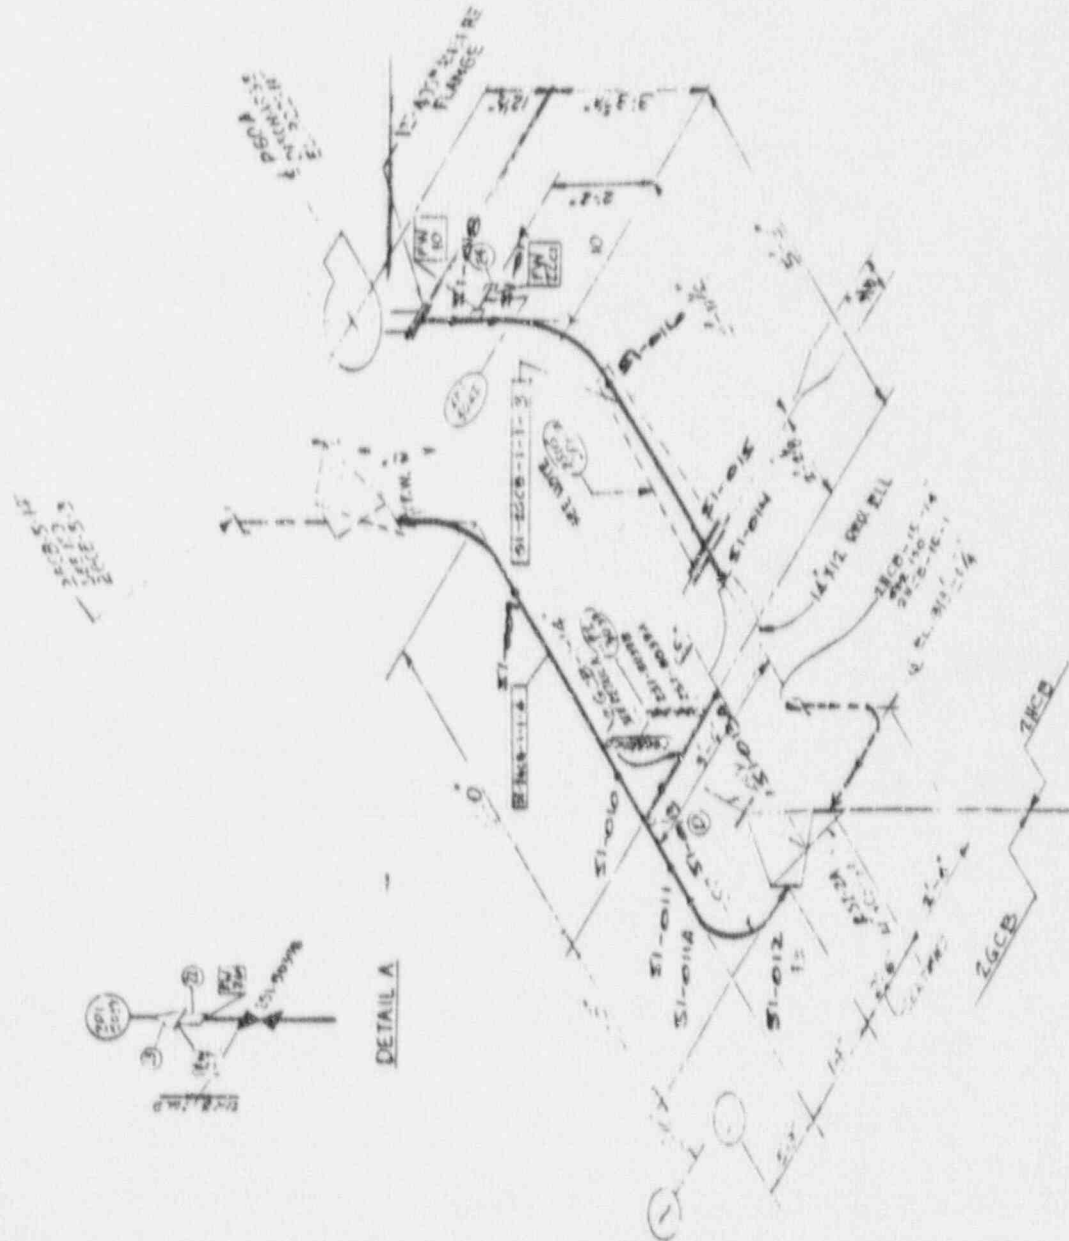

1001-2046  
 26CB-1-1  
 26CB-1-2  
 26CB-1-3














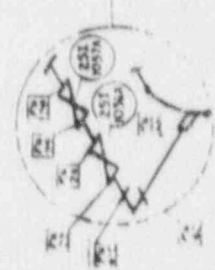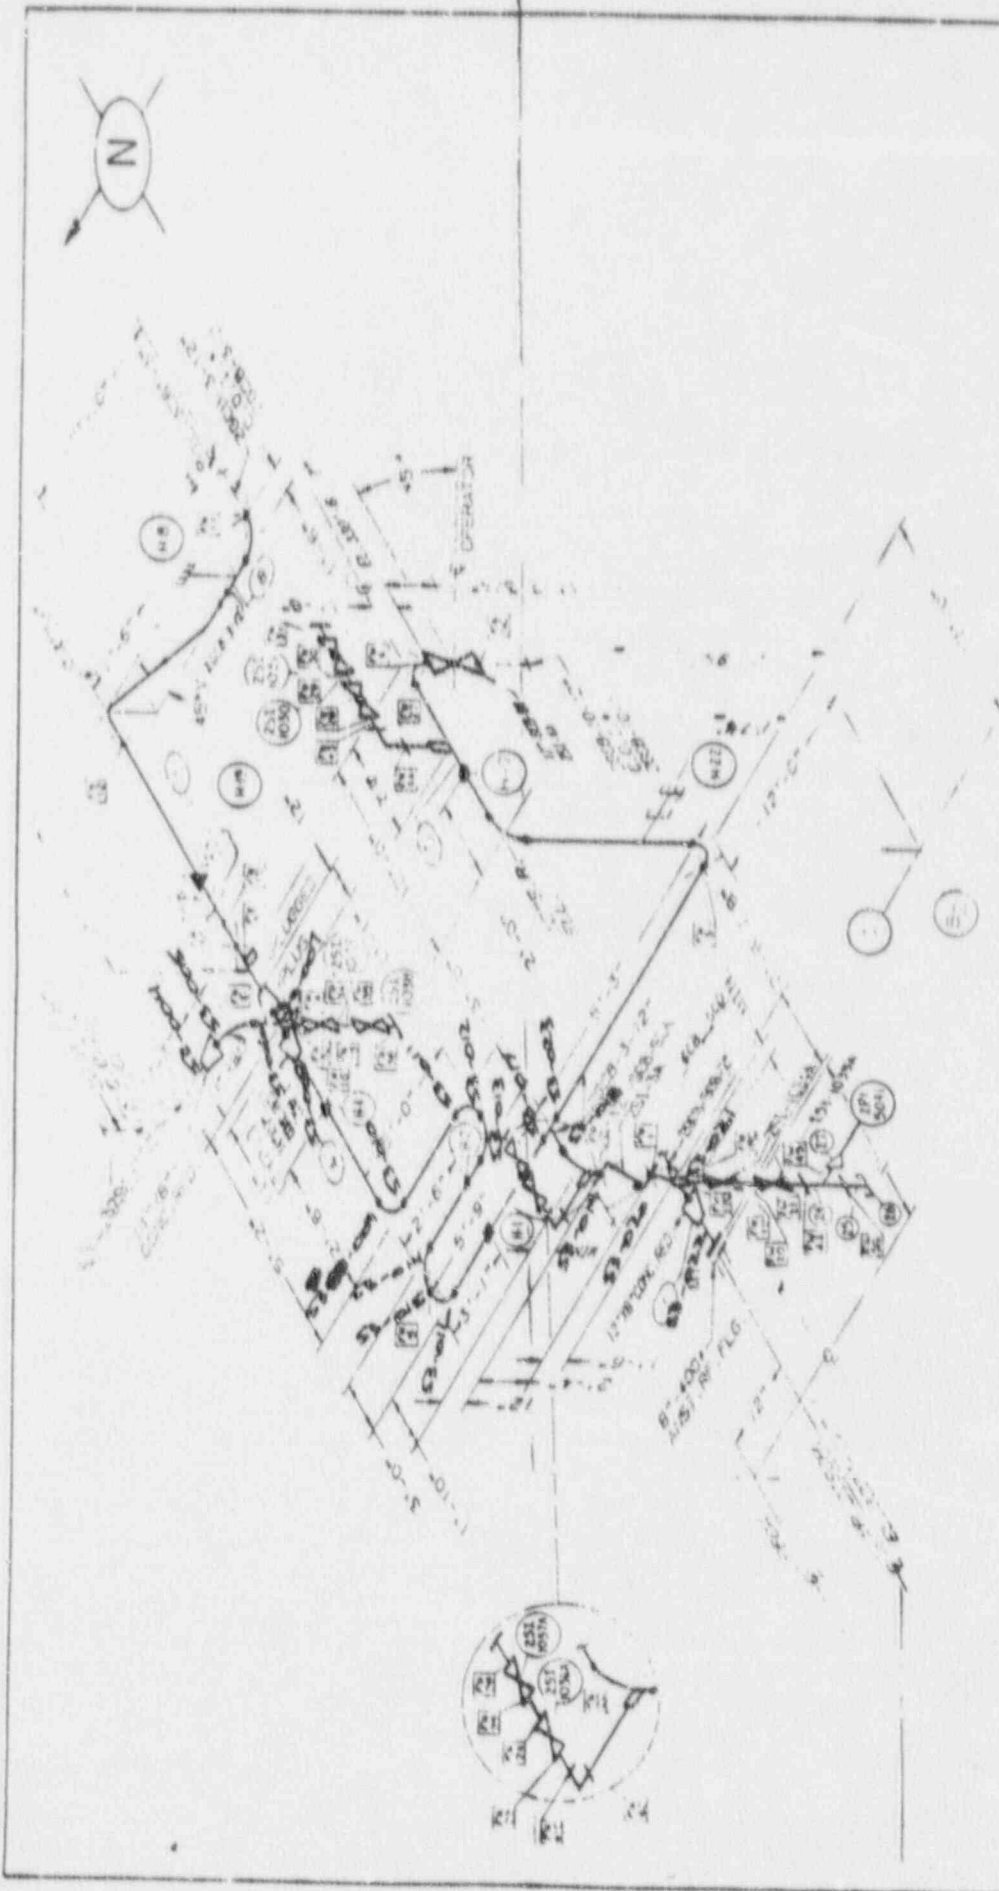

ISI-253

PROJECT: ISI-253 DRAWING NO: ISI-253-3-1 DATE: 11/1/68 BY: [Signature] CHECKED: [Signature]		ARKANSAS POWER AND LIGHT COMPANY ARKANSAS NUCLEAR ONE UNIT 2	
SYSTEM: SAFETY INJECTION SERVICE CONDITION: [Blank]		LARGES PIPE ISOMETRIC SAFETY INJECTION	
INSULATION CLASS: [Blank]		MATERIAL: [Blank]	
STARTUP NO: [Blank]		DRAWING NO: ISI-253-3-1	
THICK: [Blank]		REV: [Blank]	

95 LF

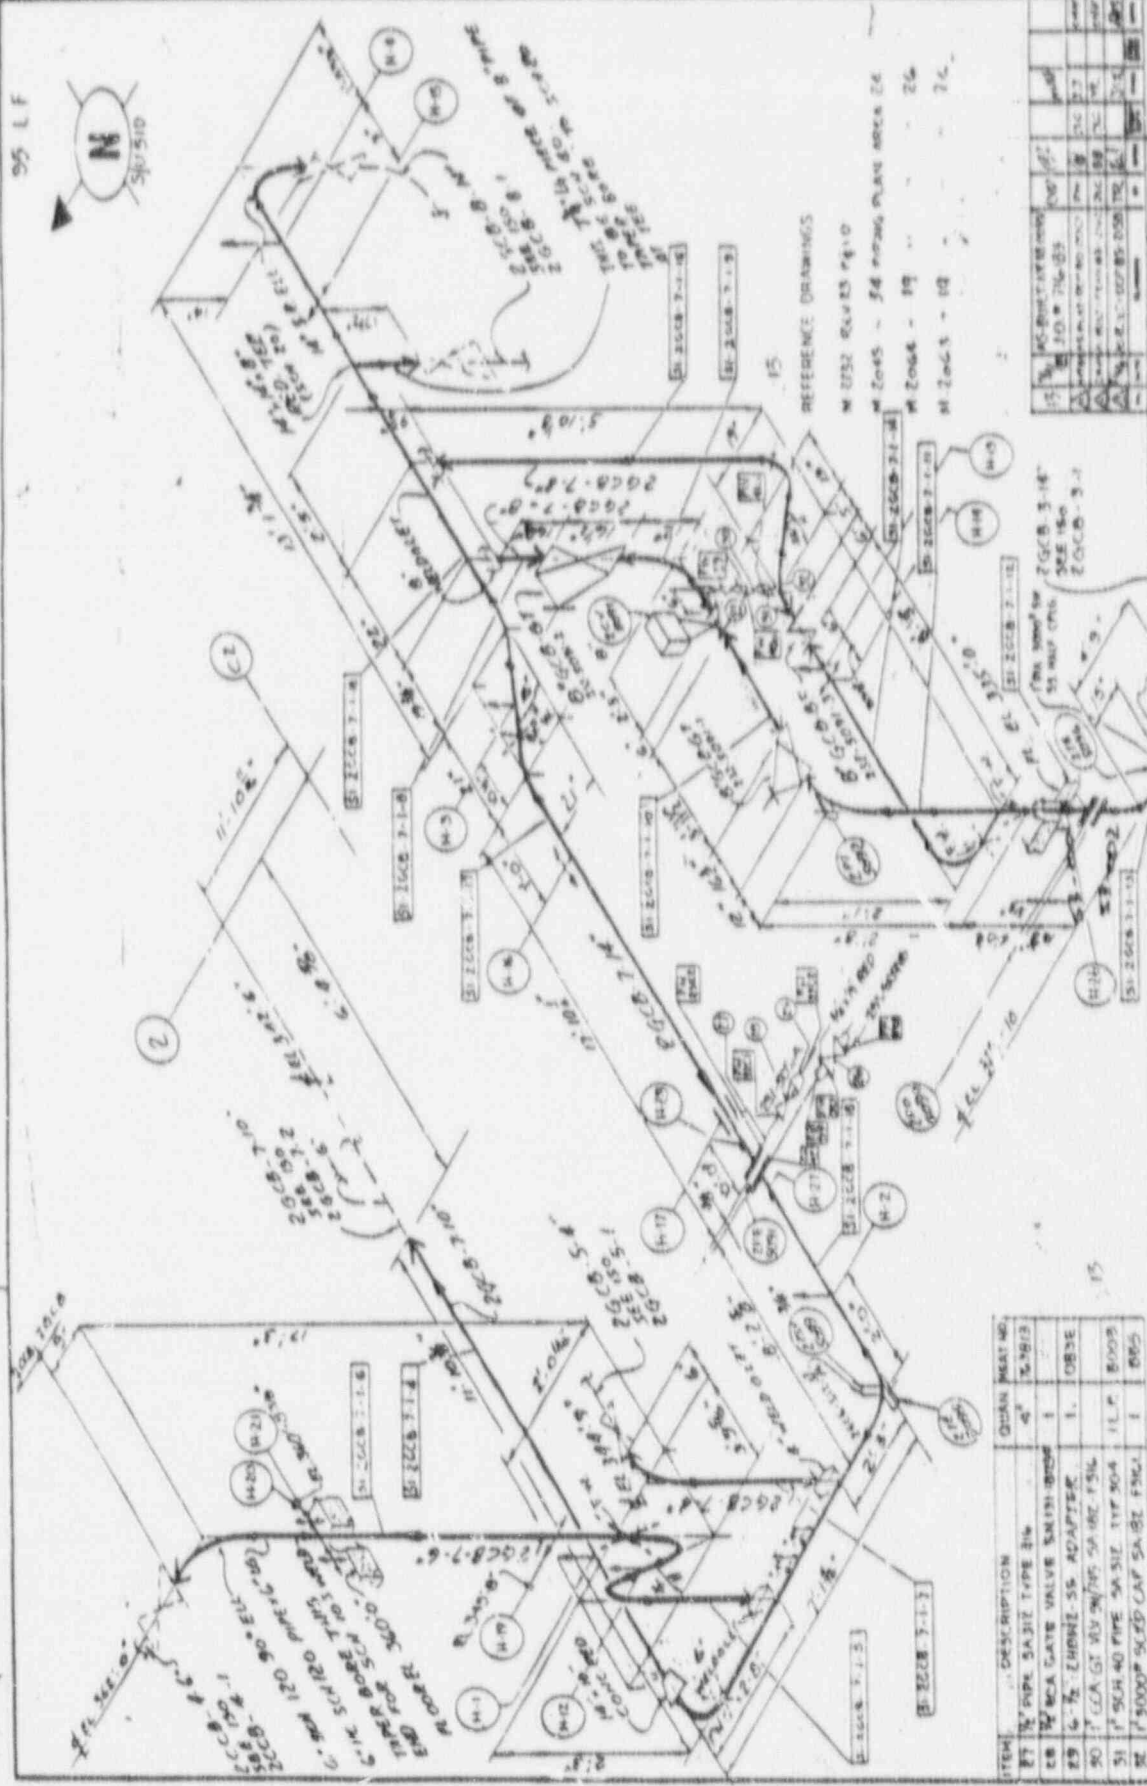

REFERENCE DRAWINGS  
M 2752 REVISED 11-10  
M 2045 - 34 PIPING PLANS AREA 24  
M 2044 - 17  
M 2043 - 10

ITEM	DESCRIPTION	QUANTITY	UNIT
87	1/2" NPT VALVE TYPE 316	1	EA
88	1/2" NPT GATE VALVE 316	1	EA
89	1/2" ZERNI-SS ADAPTER	1	EA
90	1/2" G.A. GT. 316 90° ELB. FSL	1	EA
91	1/2" SCH. 40 PIPE 316 11' 00"	1	LF
92	1" 5000' SCHED. CAP. SA. 316 FSL	1	EA

ITEM	DESCRIPTION	QUANTITY	UNIT
14	PIPE 316 - MARK NO. 31-2008-7-1-1	1	EA
15	1/2" ZERNI-SS ADAPTER	1	EA
16	1/2" G.A. GT. 316 90° ELB. FSL	1	EA
17	1/2" SCH. 40 PIPE 316 11' 00"	1	LF
18	1" 5000' SCHED. CAP. SA. 316 FSL	1	EA
19	1/2" G.A. GT. 316 90° ELB. FSL	1	EA
20	1/2" SCH. 40 PIPE 316 11' 00"	1	LF
21	1" 5000' SCHED. CAP. SA. 316 FSL	1	EA
22	1/2" G.A. GT. 316 90° ELB. FSL	1	EA

ITEM	DESCRIPTION	QUANTITY	UNIT
23	PIPE SPOOL MARK NO. 31-2008-7-1-1	1	EA
24	1/2" ZERNI-SS ADAPTER	1	EA
25	1/2" G.A. GT. 316 90° ELB. FSL	1	EA

ITEM	DESCRIPTION	QUANTITY	UNIT
1	PIPE SPOOL MARK NO. 31-2008-7-1-1	1	EA
2	1/2" ZERNI-SS ADAPTER	1	EA
3	1/2" G.A. GT. 316 90° ELB. FSL	1	EA
4	1/2" SCH. 40 PIPE 316 11' 00"	1	LF
5	1" 5000' SCHED. CAP. SA. 316 FSL	1	EA

**BECHTEL**  
SAN FRANCISCO  
AREAS FOR PIPING & LIGHT COMPANY  
ARRANGING MATERIAL USE

**ISOMETRIC CONTAINMENT AIR 04-00**  
**SAFETY INFLECTION**

66002 26-3 2608-7-1 13

ISI-253

17432

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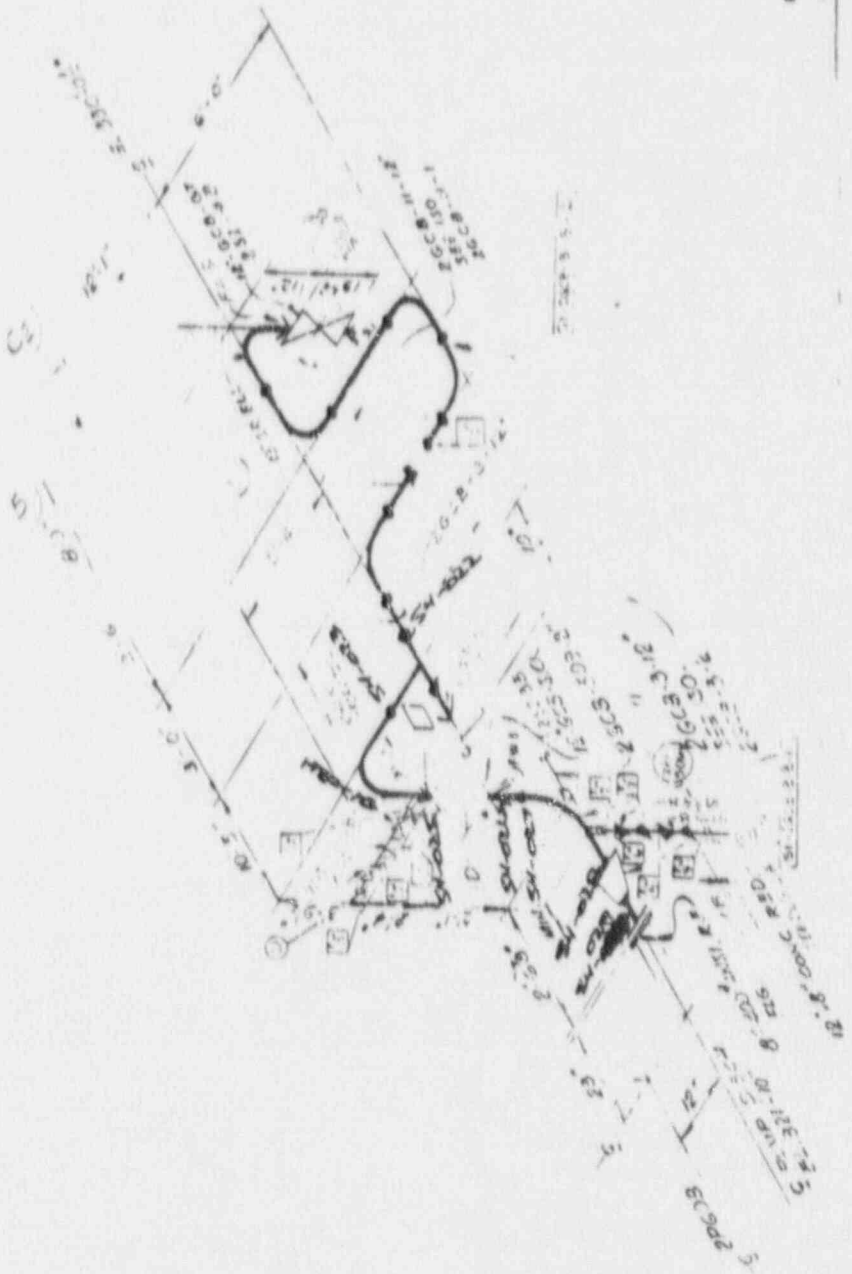


REFERENCE DRAWINGS  
 M-2282 REV. 1  
 M-2286 REV. 1  
 M-2287 REV. 1  
 M-2288 REV. 1  
 M-2289 REV. 1  
 M-2290 REV. 1  
 M-2291 REV. 1  
 M-2292 REV. 1  
 M-2293 REV. 1  
 M-2294 REV. 1  
 M-2295 REV. 1  
 M-2296 REV. 1  
 M-2297 REV. 1  
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 M-2299 REV. 1  
 M-2300 REV. 1  
 M-2301 REV. 1  
 M-2302 REV. 1  
 M-2303 REV. 1  
 M-2304 REV. 1  
 M-2305 REV. 1  
 M-2306 REV. 1  
 M-2307 REV. 1  
 M-2308 REV. 1  
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 M-2318 REV. 1  
 M-2319 REV. 1  
 M-2320 REV. 1  
 M-2321 REV. 1  
 M-2322 REV. 1  
 M-2323 REV. 1  
 M-2324 REV. 1  
 M-2325 REV. 1  
 M-2326 REV. 1  
 M-2327 REV. 1  
 M-2328 REV. 1  
 M-2329 REV. 1  
 M-2330 REV. 1  
 M-2331 REV. 1  
 M-2332 REV. 1  
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 M-2395 REV. 1  
 M-2396 REV. 1  
 M-2397 REV. 1  
 M-2398 REV. 1  
 M-2399 REV. 1  
 M-2400 REV. 1

BECHTEL SAN FRANCISCO	
AMGEN'S POWER & LIGHT COMPANY AMGEN'S NUCLEAR ONE UNIT 1	
ISOMETRIC CONTAINMENT, AUG 5, 1969 SAFETY INJECTION	
66002	26CE-3-2
5	5

ISI-254

45-L.F.



REFERENCE DRAWINGS  
M-2232 - REV 25 P.F.I.D.  
M-2236 - REV 24 P.F.I.D.  
M-2045 - REV 20 P.F.I.D. 2/26/52

ISI-254

BECHTEL SAN FRANCISCO	
ARABAS POWER & LIGHT COMPANY ARABAS RECLER ONE	
UNIT 2	
ISOMETRIC - CONTAINMENT AUXILIARY SAFETY SECTION	
66002	26CB-3-3
17x22	

1	200-8-3-1	3/4" SCH 40S	1
2	200-8-3-2	3/4" SCH 40S	1
3	200-8-3-3	3/4" SCH 40S	1
4	200-8-3-4	3/4" SCH 40S	1
5	200-8-3-5	3/4" SCH 40S	1
6	200-8-3-6	3/4" SCH 40S	1
7	200-8-3-7	3/4" SCH 40S	1
8	200-8-3-8	3/4" SCH 40S	1
9	200-8-3-9	3/4" SCH 40S	1
10	200-8-3-10	3/4" SCH 40S	1
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21	200-8-3-21	3/4" SCH 40S	1
22	200-8-3-22	3/4" SCH 40S	1
23	200-8-3-23	3/4" SCH 40S	1
24	200-8-3-24	3/4" SCH 40S	1
25	200-8-3-25	3/4" SCH 40S	1
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31	200-8-3-31	3/4" SCH 40S	1
32	200-8-3-32	3/4" SCH 40S	1
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35	200-8-3-35	3/4" SCH 40S	1
36	200-8-3-36	3/4" SCH 40S	1
37	200-8-3-37	3/4" SCH 40S	1
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40	200-8-3-40	3/4" SCH 40S	1
41	200-8-3-41	3/4" SCH 40S	1
42	200-8-3-42	3/4" SCH 40S	1
43	200-8-3-43	3/4" SCH 40S	1
44	200-8-3-44	3/4" SCH 40S	1
45	200-8-3-45	3/4" SCH 40S	1
46	200-8-3-46	3/4" SCH 40S	1
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98	200-8-3-98	3/4" SCH 40S	1
99	200-8-3-99	3/4" SCH 40S	1
100	200-8-3-100	3/4" SCH 40S	1

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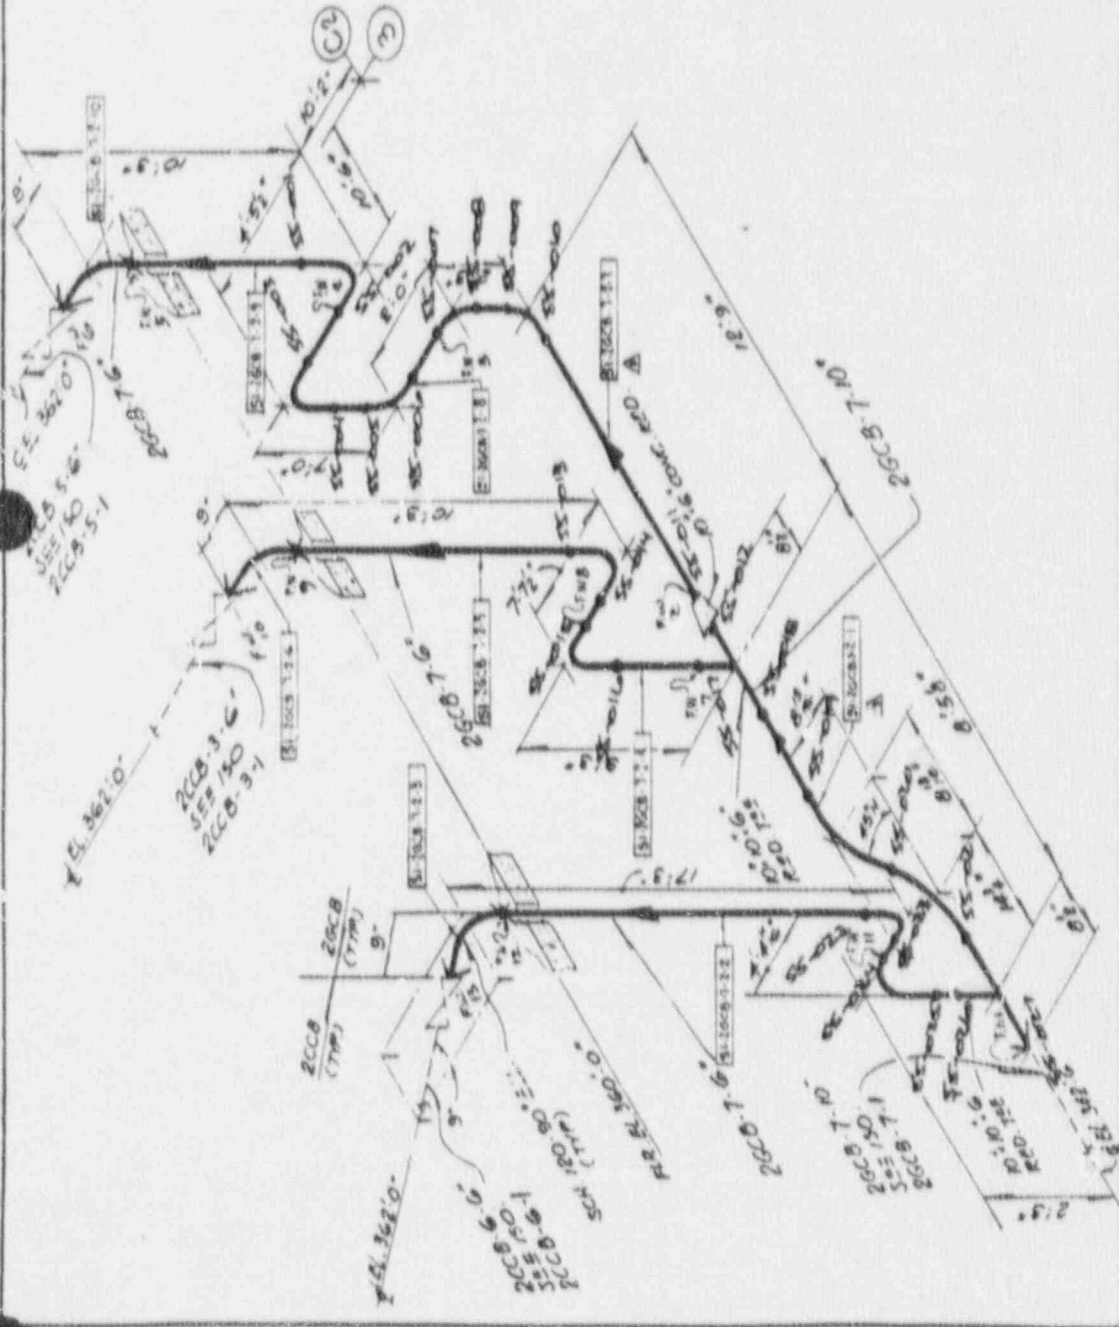




101-L



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- REFERENCE DRAWINGS
- M-2232 REV 23 P+1-D
  - M-2044 - 26 PIPING PLAN - AREA 24
  - M-2045 - 34 - - - - 24
  - M-2063 - 17 - - - - 26
  - M-2064 - 11 - - - - 26

NO.	DATE	BY	CHKD	DESCRIPTION
1	10/1/54	J. H. HARRIS		ISSUED FOR CONSTRUCTION
2	10/1/54	J. H. HARRIS		ISSUED FOR CONSTRUCTION
3	10/1/54	J. H. HARRIS		ISSUED FOR CONSTRUCTION
4	10/1/54	J. H. HARRIS		ISSUED FOR CONSTRUCTION
5	10/1/54	J. H. HARRIS		ISSUED FOR CONSTRUCTION
6	10/1/54	J. H. HARRIS		ISSUED FOR CONSTRUCTION
7	10/1/54	J. H. HARRIS		ISSUED FOR CONSTRUCTION
8	10/1/54	J. H. HARRIS		ISSUED FOR CONSTRUCTION
9	10/1/54	J. H. HARRIS		ISSUED FOR CONSTRUCTION
10	10/1/54	J. H. HARRIS		ISSUED FOR CONSTRUCTION

**BECHTEL**  
SAN FRANCISCO

ARMASAS POWER & LIGHT COMPANY  
ARMASAS NUCLEAR ONE  
UNIT 2

ISOMETRIC COMPANIMENT AUX BEAC  
SAFETY INJECTION

66002 26CB-7-2

ISI-255

Bill Of Material

QTY	DESCRIPTION	QTY
1	PIPE SPOOL MARK: 26CB-7-2-1	1
2	PIPE SPOOL MARK: 26CB-7-2-2	2
1	PIPE SPOOL MARK: 26CB-7-2-3	1
2	PIPE SPOOL MARK: 26CB-7-2-4	2
5	PIPE SPOOL MARK: 26CB-7-2-5	5
4	PIPE SPOOL MARK: 26CB-7-2-6	4
7	PIPE SPOOL MARK: 26CB-7-2-7	7
5	PIPE SPOOL MARK: 26CB-7-2-8	5
1	PIPE SPOOL MARK: 26CB-7-2-9	1
10	PIPE SPOOL MARK: 26CB-7-2-10	10

I certify that the image contained on this frame was taken from the original and regular end of the film, on the date stated below and that it is an accurate reproduction of the document submitted to Micrographics.

DATE 10/1/54

16X

17432

























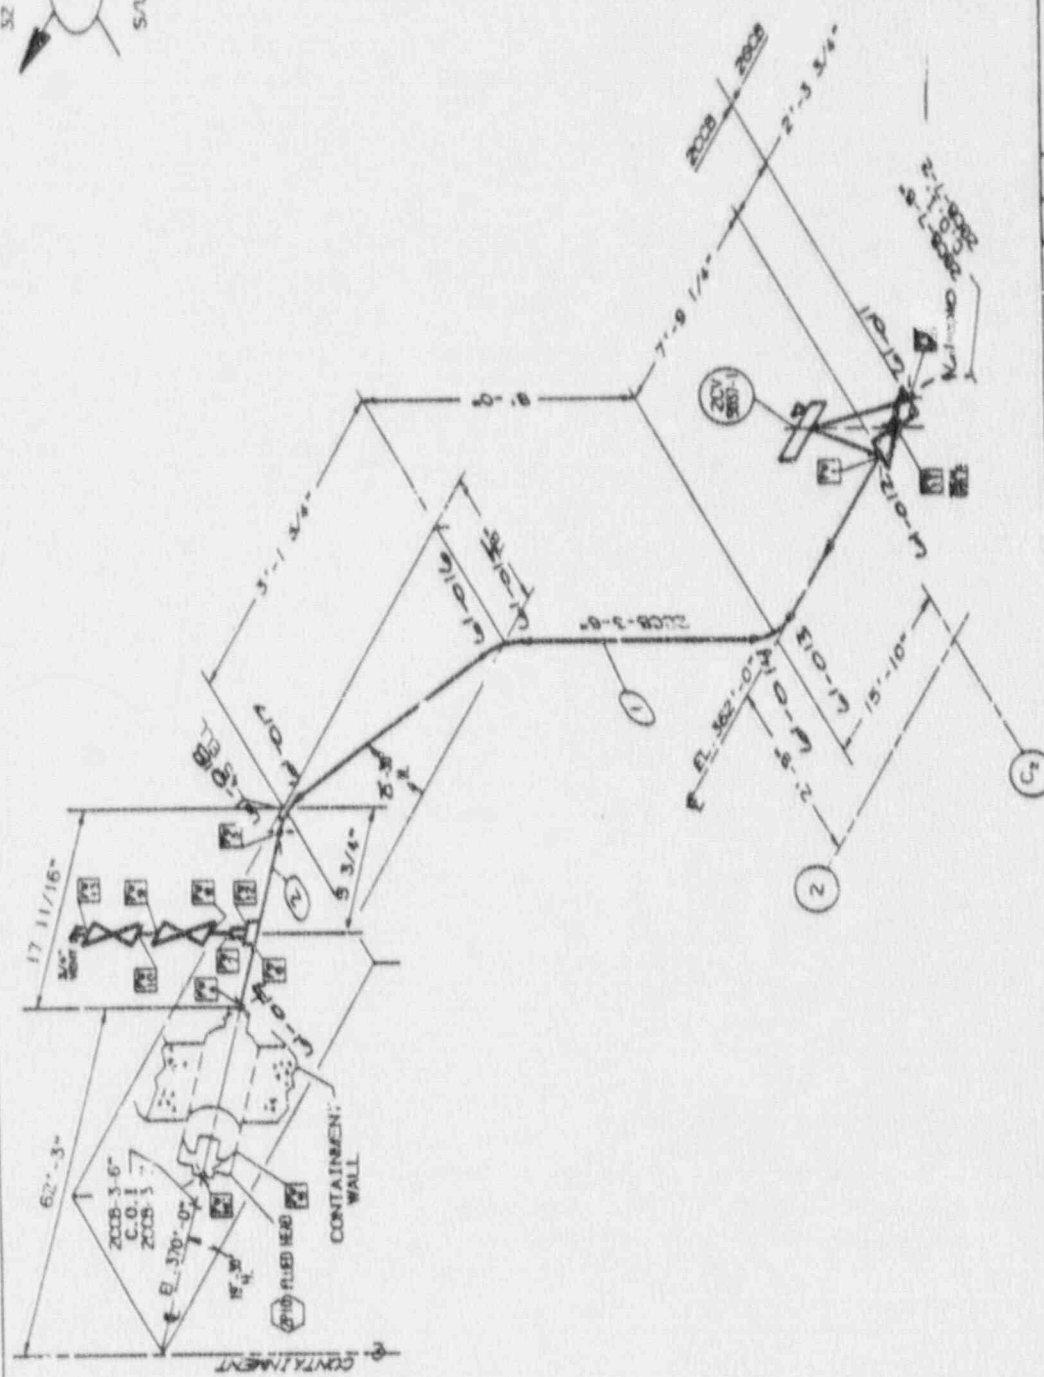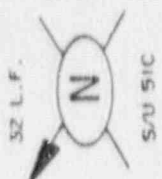

REFERENCE P.B.D. NO. M-2232 PIPING DES. M-2054 AREA NO. 24 BLDG. REACTOR AUX. SYS. SAFETY INJECTION SYSTEM	DESIGN ORGANIZATION QUALITY P.D. (H) REVISIONS SCALE NONE DESIGN JACOBS DRAWN BIRRELL ARKANSAS POWER AND LIGHT COMPANY ARKANSAS NUCLEAR ONE UNIT 2
NAME TYPE DWS NO. EYE CLEARING HEIGHT SERVICE CONDITIONS NORMAL MAXIMUM	LARGE PIPE ISOMETRIC SAFETY INJECTION SYSTEM 
STARTUP NO. INSULATION CLASS THICK	DRAWING NO. 2CCB-3-1 REV. 6

ITEM	QTY	DESCRIPTION	HEAT NO.	ASTM	DRG
1	1	1" 3/4" 8000# A-182 RED. INSERT			FS18
2	1	1/2" 3" 15 8000# A-182 RED. THROBT.			FS18
3	1	3/4" 8000# SA-182 THRO. CAP			FS18
4	1	3/4" 4" 6CA-36 VALVE			1931B
5	1	3/4" 4" 4" WRENCH BSH 180 PIPE SA-312			1931B
6	1	1/4" 2" 4" WRENCH BSH 180 PIPE SA-312			1931B
7	1	1/2" 2" 4" WRENCH BSH 180 PIPE SA-312			1931B
8	1	3/4" 2" 4" WRENCH BSH 180 PIPE SA-312			1931B
9	1	1/2" 2" 4" WRENCH BSH 180 PIPE SA-312			1931B
10	1	3/4" 2" 4" WRENCH BSH 180 PIPE SA-312			1931B
11	1	1/2" 2" 4" WRENCH BSH 180 PIPE SA-312			1931B
12	1	3/4" 2" 4" WRENCH BSH 180 PIPE SA-312			1931B
13	1	1/2" 2" 4" WRENCH BSH 180 PIPE SA-312			1931B
14	1	3/4" 2" 4" WRENCH BSH 180 PIPE SA-312			1931B
15	1	1/2" 2" 4" WRENCH BSH 180 PIPE SA-312			1931B
16	1	3/4" 2" 4" WRENCH BSH 180 PIPE SA-312			1931B
17	1	1/2" 2" 4" WRENCH BSH 180 PIPE SA-312			1931B
18	1	3/4" 2" 4" WRENCH BSH 180 PIPE SA-312			1931B
19	1	1/2" 2" 4" WRENCH BSH 180 PIPE SA-312			1931B
20	1	3/4" 2" 4" WRENCH BSH 180 PIPE SA-312			1931B
21	1	1/2" 2" 4" WRENCH BSH 180 PIPE SA-312			1931B
22	1	3/4" 2" 4" WRENCH BSH 180 PIPE SA-312			1931B
23	1	1/2" 2" 4" WRENCH BSH 180 PIPE SA-312			1931B
24	1	3/4" 2" 4" WRENCH BSH 180 PIPE SA-312			1931B
25	1	1/2" 2" 4" WRENCH BSH 180 PIPE SA-312			1931B
26	1	3/4" 2" 4" WRENCH BSH 180 PIPE SA-312			1931B
27	1	1/2" 2" 4" WRENCH BSH 180 PIPE SA-312			1931B
28	1	3/4" 2" 4" WRENCH BSH 180 PIPE SA-312			1931B
29	1	1/2" 2" 4" WRENCH BSH 180 PIPE SA-312			1931B
30	1	3/4" 2" 4" WRENCH BSH 180 PIPE SA-312			1931B
31	1	1/2" 2" 4" WRENCH BSH 180 PIPE SA-312			1931B
32	1	3/4" 2" 4" WRENCH BSH 180 PIPE SA-312			1931B
33	1	1/2" 2" 4" WRENCH BSH 180 PIPE SA-312			1931B
34	1	3/4" 2" 4" WRENCH BSH 180 PIPE SA-312			1931B
35	1	1/2" 2" 4" WRENCH BSH 180 PIPE SA-312			1931B
36	1	3/4" 2" 4" WRENCH BSH 180 PIPE SA-312			1931B
37	1	1/2" 2" 4" WRENCH BSH 180 PIPE SA-312			1931B
38	1	3/4" 2" 4" WRENCH BSH 180 PIPE SA-312			1931B
39	1	1/2" 2" 4" WRENCH BSH 180 PIPE SA-312			1931B
40	1	3/4" 2" 4" WRENCH BSH 180 PIPE SA-312			1931B
41	1	1/2" 2" 4" WRENCH BSH 180 PIPE SA-312			1931B
42	1	3/4" 2" 4" WRENCH BSH 180 PIPE SA-312			1931B
43	1	1/2" 2" 4" WRENCH BSH 180 PIPE SA-312			1931B
44	1	3/4" 2" 4" WRENCH BSH 180 PIPE SA-312			1931B
45	1	1/2" 2" 4" WRENCH BSH 180 PIPE SA-312			1931B
46	1	3/4" 2" 4" WRENCH BSH 180 PIPE SA-312			1931B
47	1	1/2" 2" 4" WRENCH BSH 180 PIPE SA-312			1931B
48	1	3/4" 2" 4" WRENCH BSH 180 PIPE SA-312			1931B
49	1	1/2" 2" 4" WRENCH BSH 180 PIPE SA-312			1931B
50	1	3/4" 2" 4" WRENCH BSH 180 PIPE SA-312			1931B










ISL.F.



S/U #51C

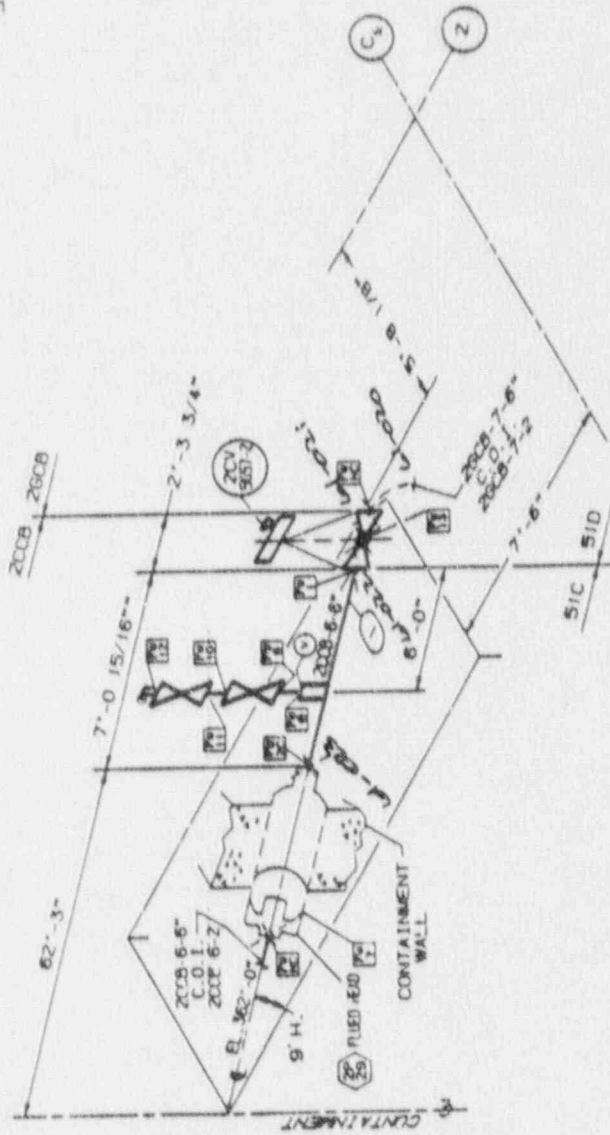

<p>REFERENCE</p> <p>P&amp;ID NO. M-2232</p> <p>PIPING DES. M-2063</p> <p>AREA NO. 208</p> <p>BLDG. REACTOR AUX.</p> <p>SYS. SAFETY INJECTION</p>	<p>NO. 5</p> <p>DATE 11/15/68</p> <p>BY J. W. HARRIS</p> <p>SCALE 1/8" = 1'-0"</p> <p>PROJECT ARKANSAS NUCLEAR ONE UNIT 2</p>
<p>OWNER TYPE</p> <p>ARKANSAS POWER AND LIGHT COMPANY</p> <p>2ND CLASS. DESIG.</p> <p>DESIGN NO. 208</p> <p>DESIGN DATE 11/15/68</p>	<p>OPERATOR NO. 2008-6-1</p> <p>REV. 5</p>

ITEM	QTY	DESCRIPTION	HEAT NO.	ASTM	END
1	1	3/4" BRASS THERM. CAP SA 182			
2	1	3/4" X 4" PE X TE SON. 180 PIPE SA 312			
3	2	3/4" BR. COA 88 VALVES			
4	1	3/4" X 4" PE X TE SON. 180 PIPE SA 312			
5	1	6" SCH. 40S-2			
6	1	SPRAL. PIECE BR. SI 2008-6-1-1			

ISL-261












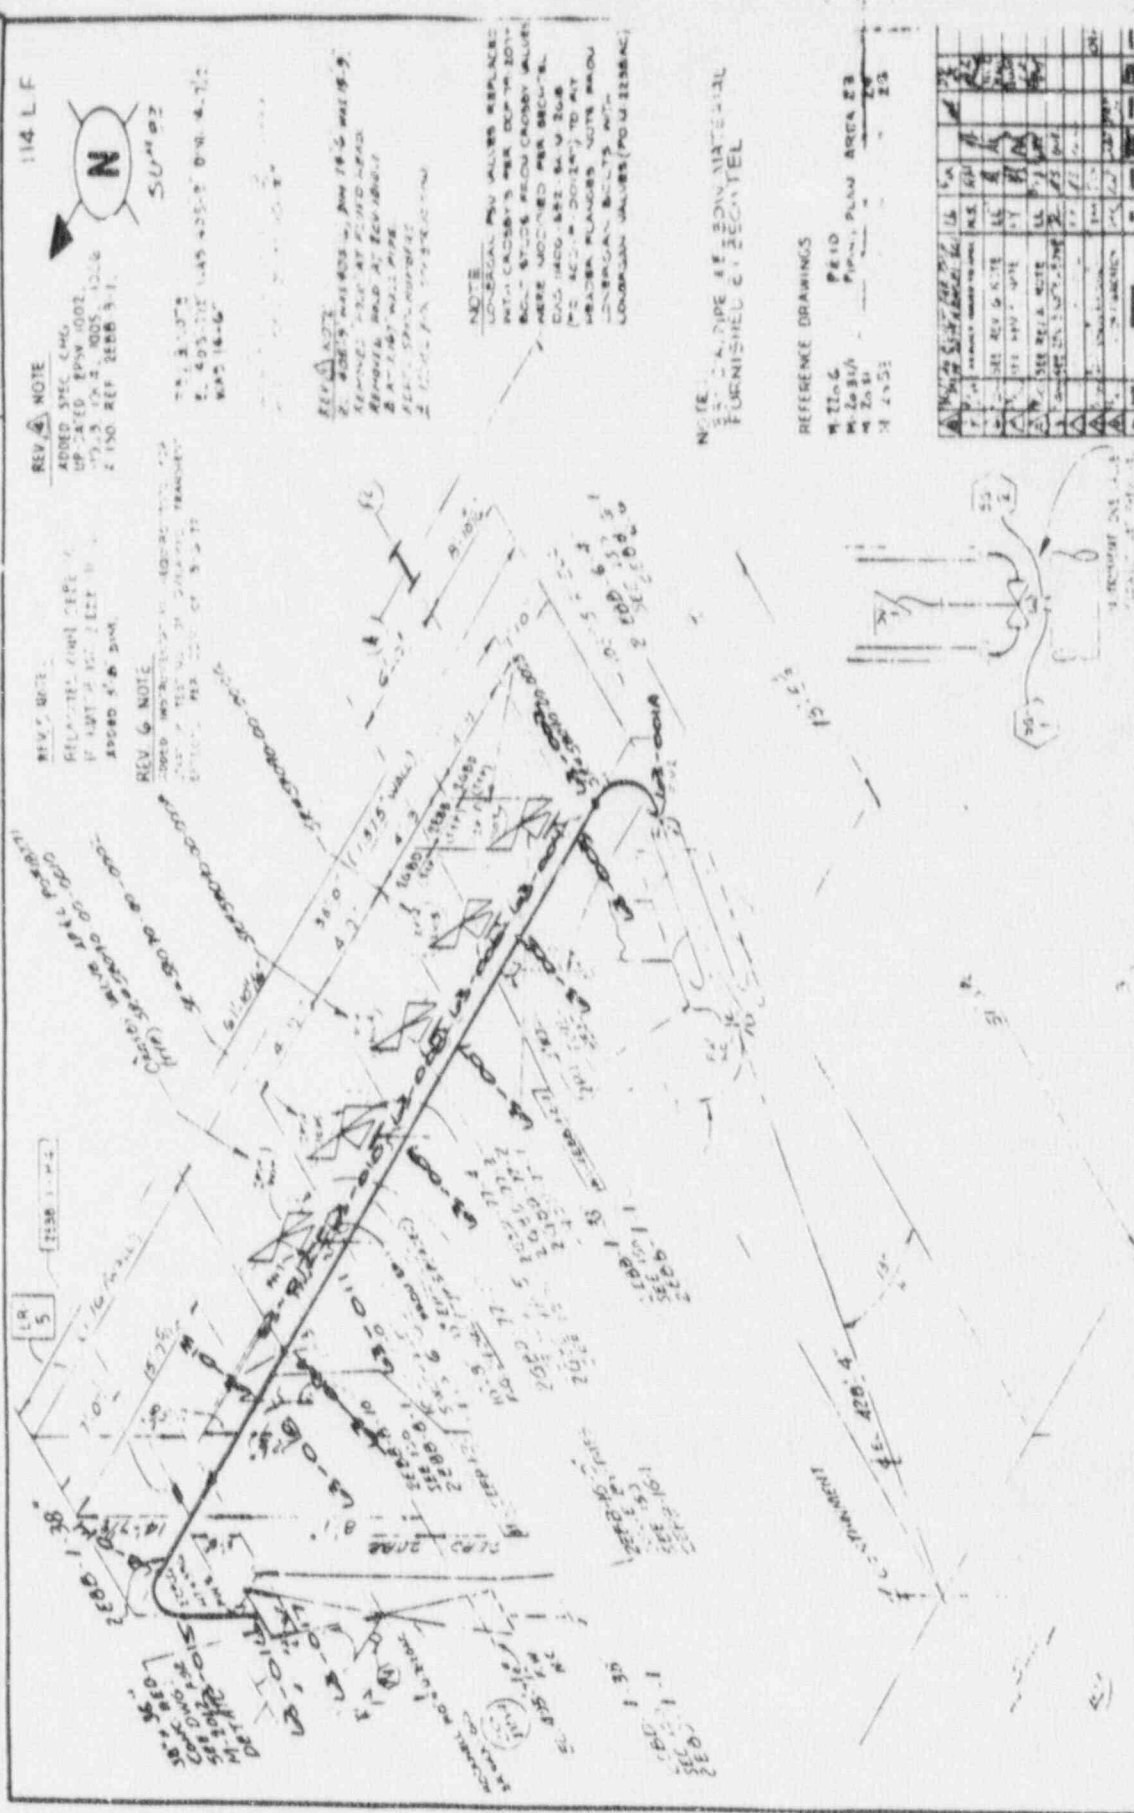

114 L F

REV. 4 NOTE  
 ADDED SPEC CHG.  
 UP DATED EPSW 1002  
 17.5 IN. 2. 400S. 10.1.6  
 2 INO REF 2EBB 3-1

REV. 5  
 17.5 IN. 2. 400S. 10.1.6  
 2 INO REF 2EBB 3-1

REV. 6 NOTE  
 ADDED SPEC CHG.  
 UP DATED EPSW 1002  
 17.5 IN. 2. 400S. 10.1.6  
 2 INO REF 2EBB 3-1

NOTE  
 GENERAL PIPE VALUES REPLACE  
 WITH CALORIFY PER SUPPLIER  
 ALL STEEL PIPE CHERRY VALVE  
 WERE ADVISED PER BECHTEL  
 DSG 1400 ARE 84.0 INCH  
 PER 100-10017 TO 100-10018  
 BECHTEL PLUGS NOTE AROUND  
 LONGHORN VALVES (POU 12384C)

NOTE  
 2. 4. PIPE IS BDN MATERIAL  
 FURNISHED BY BECHTEL

REFERENCE DRAWINGS  
 M-2206  
 M-2081A  
 M-2081  
 M-2082

NO.	DESCRIPTION	DATE	BY	CHKD.
1	ISSUED FOR CONSTRUCTION	10/1/53	J. H. ...	J. H. ...
2	REVISED	10/1/53	J. H. ...	J. H. ...
3	REVISED	10/1/53	J. H. ...	J. H. ...
4	REVISED	10/1/53	J. H. ...	J. H. ...
5	REVISED	10/1/53	J. H. ...	J. H. ...
6	REVISED	10/1/53	J. H. ...	J. H. ...
7	REVISED	10/1/53	J. H. ...	J. H. ...
8	REVISED	10/1/53	J. H. ...	J. H. ...
9	REVISED	10/1/53	J. H. ...	J. H. ...
10	REVISED	10/1/53	J. H. ...	J. H. ...

BECHTEL  
 SAN FRANCISCO

AMERASAS POWER & LIGHT COMPANY  
 AMERASAS REACTOR ONE  
 UNIT 2

ISOMETRIC TURENE AVE. BLDG  
 MAIN STEAM

66002 2EBB.12

ISI-263


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15 L.F.



S/U # 63 183

REFERENCE DRAWINGS  
M-2206 REV 12 P E 10  
M-2031 - TB PIPING PLAN AREA C3

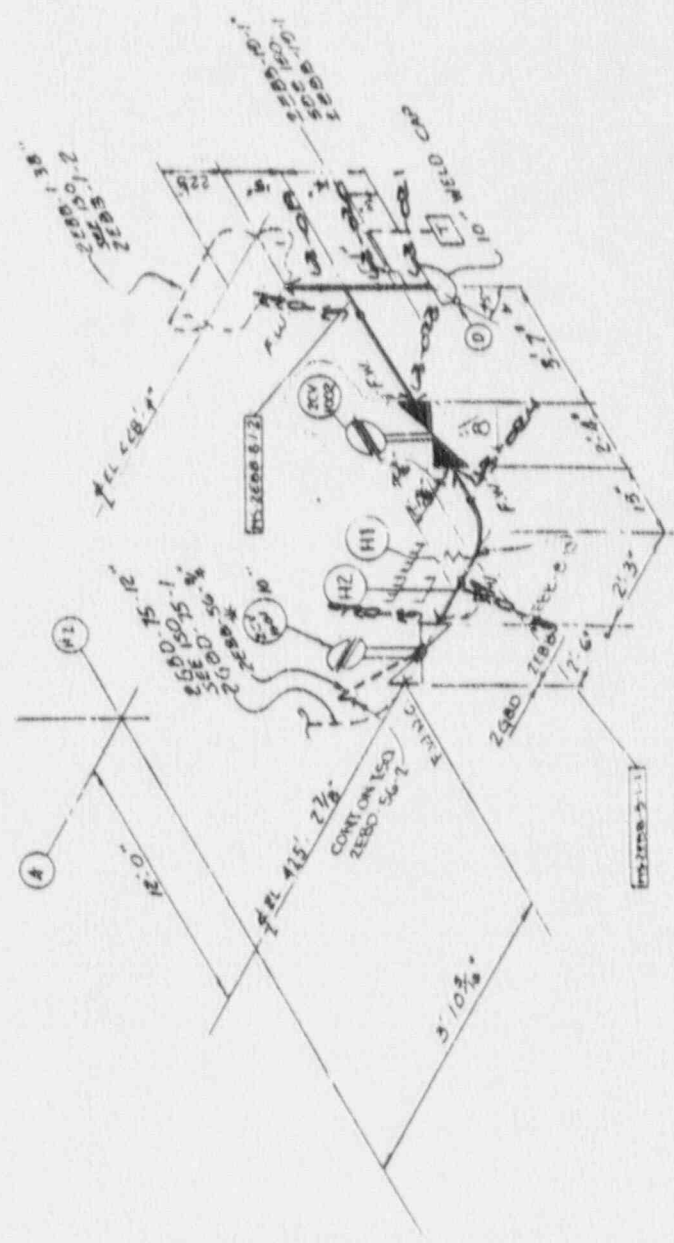

1	1" Pipe Spec. Max: MS-2888-B-1-1	1
2	10' ZCU-1001	2
3	10' ZCU-1002	2
4	10' ZCU-1003	2
5	10' ZCU-1004	2

NO.	DESCRIPTION	DATE	BY	CHKD.
1	ISSUED FOR CONSTRUCTION	10/1/58	J. W. B.	J. W. B.
2	REVISION			
3	REVISION			
4	REVISION			
5	REVISION			
6	REVISION			
7	REVISION			
8	REVISION			
9	REVISION			
10	REVISION			

BECHTEL  
SAN FRANCISCO

AMERICAN POWER & LIGHT COMPANY  
AMERICAN NUCLEAR ONE  
UNIT 2

ISOMETRIC - TURBINE AUX BLDG  
MAIN STEAM

66002 2 EDB-8-1 8

ISI-263

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25 Lin Ft.



REV. 1 NOTE:  
 ADD 15' OF MAT'L. SPOOL NOS. P.M. NOS.  
 ISSUED FOR CONST.

REV. A NOTE:

10' WAS 10 3/4" ADDED 10 1/2" PIPE SPOOL  
 GRINNELL TO FABRICATE AND TO ISSUE  
 SPOOL NO. 255 L.F. WAS 36 L.F.


REV. 10 NOTE:

PER PERMIT FOR T1-4 WAS CHANGED  
 TO P1-25. THIS REV NOTE SHALL BE  
 DELETED AT THE NEXT R.L.V. OF THIS NO.



REFERENCE DRAWINGS

M-2206 REV.22 P.1.D.  
 M-2032 - 35 PIPING PLAN AREA 23  
 M-2033 - 31

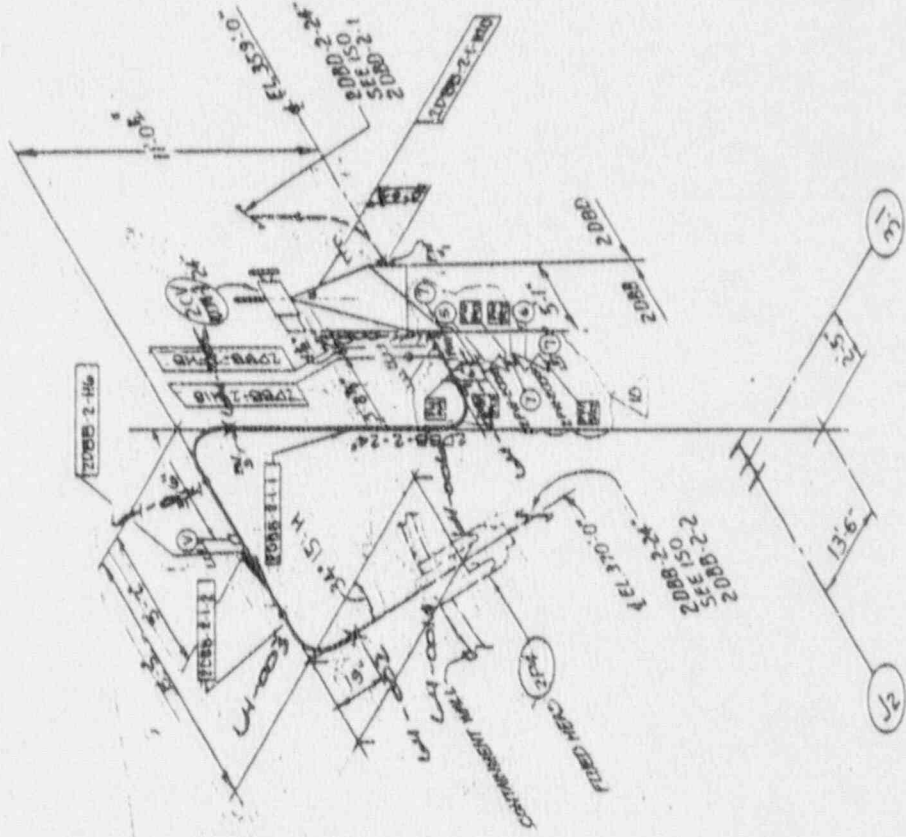

ITEM NO.	DESCRIPTION	QUANTITY
1	10' SPOOL MARK 200B-2-11	1
2	10' SPOOL MARK 200B-2-12	1
3	24" ICV 10' 4	1
4	10' SPOOL MARK - 200B-2-1-3	1
5	1" CB&I VALVE 8" NPT/1/2" STROKE	1
6	1" CB&I VALVE 8" NPT/1/2" STROKE	1
7	1" CB&I VALVE 8" NPT/1/2" STROKE	1
100	1" CB&I VALVE 8" NPT/1/2" STROKE	1

<p>BECHTEL                  SAN FRANCISCO                  ARMAKAS POWER &amp; LIGHT COMPANY                  ARMAKAS NUCLEAR ONE                  UNIT 2</p>	<p>ISO METRIC - TURBINE AUX. BLD'G                  MAIN FEEDWATER</p>
<p>66002</p>	<p>2 DBB-2-1</p>

ISI-264

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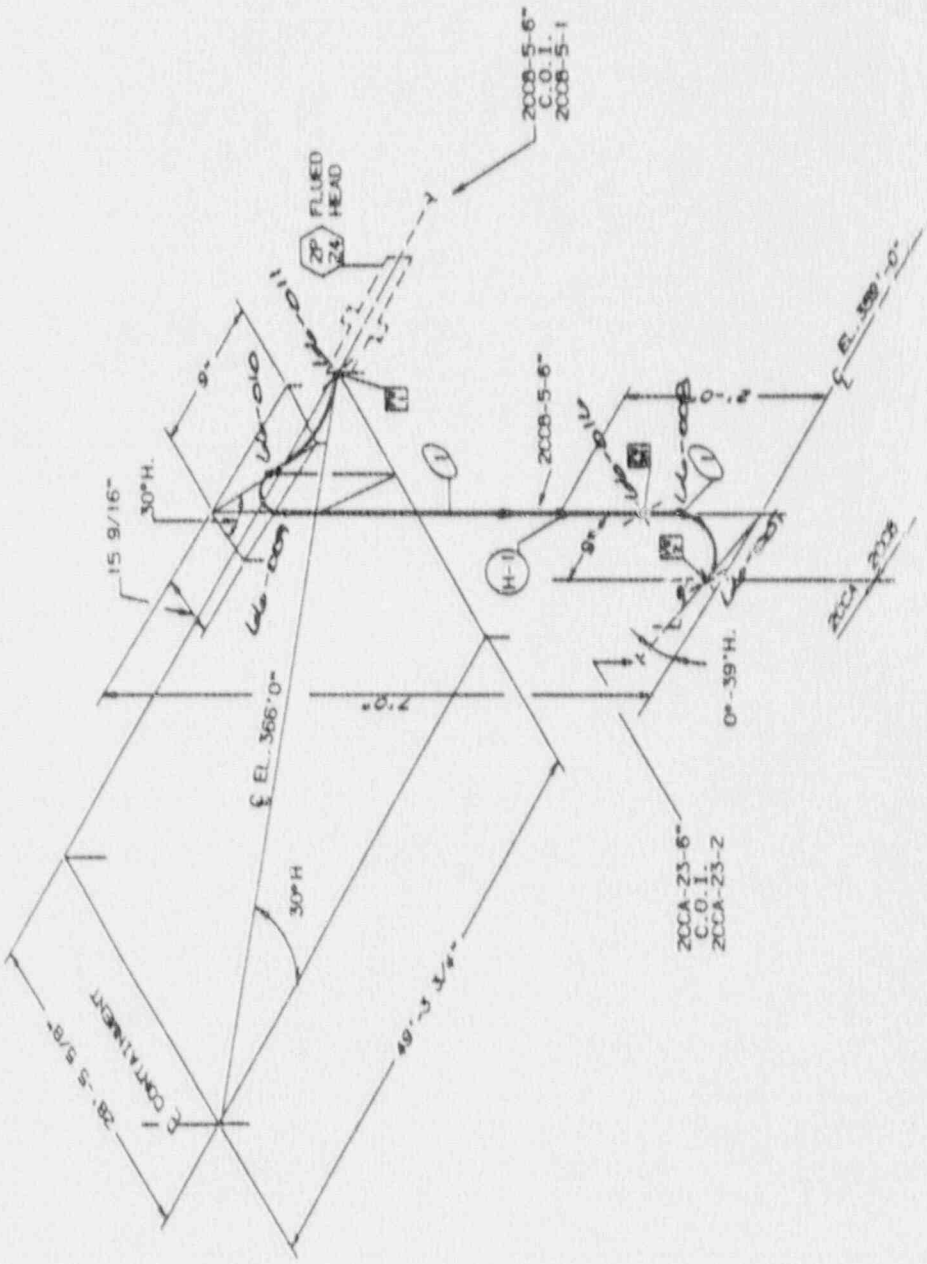
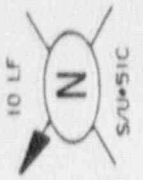












ITEM	QTY.	TYPE	SP. NO.	DESCRIPTION	WEIGHT	ASTM	SP. NO.
1	1	PIPE	SP. NO. 21	2008-5-2-1			
1	1	FLANGED		HEAD			

BILL OF MATERIAL

STARTUP NO.

ISOLATION CLASS

THICK


REFERENCE	FIELD NO. M-2232
	PIPING DES. M-2008
	AREA NO. 201
	BLDG. REACTOR
	SVS SAFETY INJECTION
	NUMBER TYPE
	DATE NO.
	SVS CLEARING NO.
	SERVICE CONDITIONS
	NORMAL
	MAXIMUM
	PART
	FRAM

AP	2008-5-2	4
LARGE PIPE ISOMETRIC SAFETY INJECTION SYSTEM		
ARKANSAS POWER AND LIGHT COMPANY ARKANSAS NUCLEAR ONE UNIT 2		
DATE	BY	CHKD.
10/1/82	J. W. BROWN	J. W. BROWN
10/1/82	J. W. BROWN	J. W. BROWN
10/1/82	J. W. BROWN	J. W. BROWN
10/1/82	J. W. BROWN	J. W. BROWN





S/U • 5/C

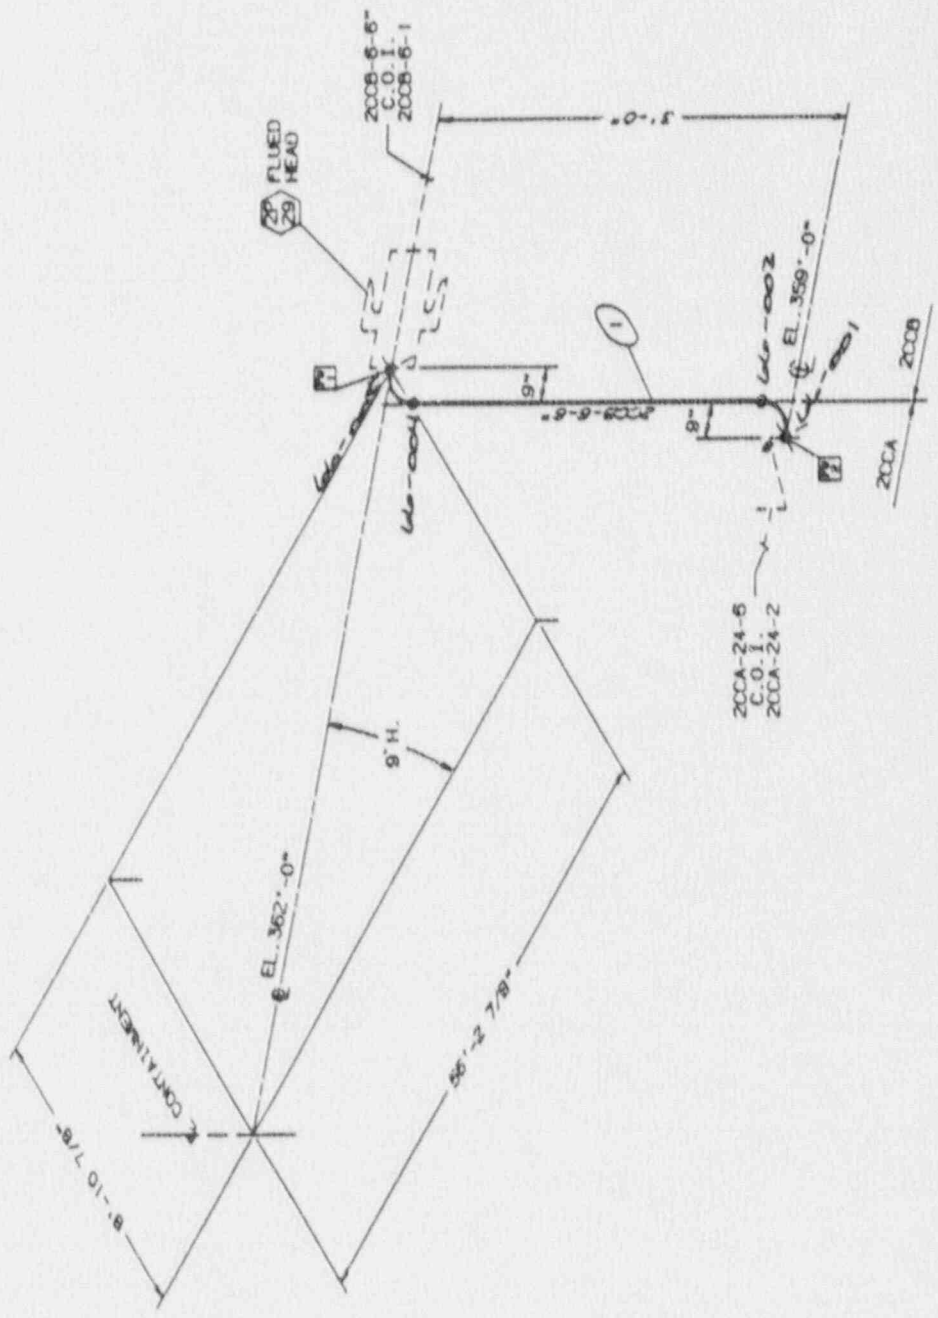

ITEM	QTY	DESCRIPTION	HEAT NO	ASTM	GRID
1	1	PIPE BRK. SI-2008-6-2-1			

STARTUP NO	INSULATION CLASS	THICK

REFERENCE	
P.B.L.D. NO.	M-2232
APPROV. DATE	11-2008
AREA NO.	25
B.L.D.G. REACTOR BLDG.	ELEV.
SYS.	SAFETY INJECTION SYSTEM
NUMBER TYPE	
DRAW NO.	
SYS. CLEARING NO.	
SERVICE CONDITIONS	
TEMPERATURE	
PRESSURE	
MATERIAL	

SCALE	DATE	BY	CHKD BY
AS SHOWN			



  

REVISION	DATE	BY	CHKD BY
1			

ARIZONA POWER AND LIGHT COMPANY	
ARIZONA NUCLEAR ONE	
UNIT	
LARGE PIPE ISOMETRIC	
SAFETY INJECTION SYSTEM	
STARTUP NO.	2008-6-2
REV.	3





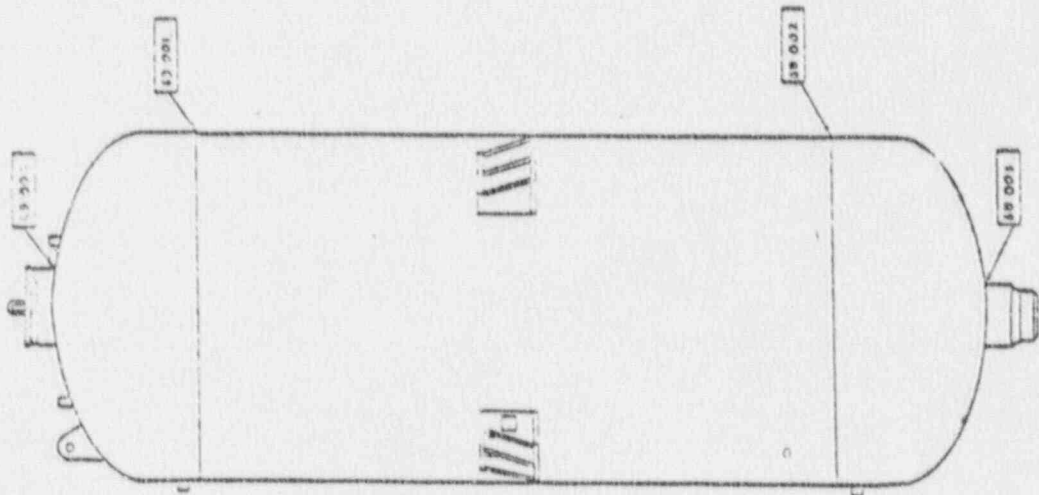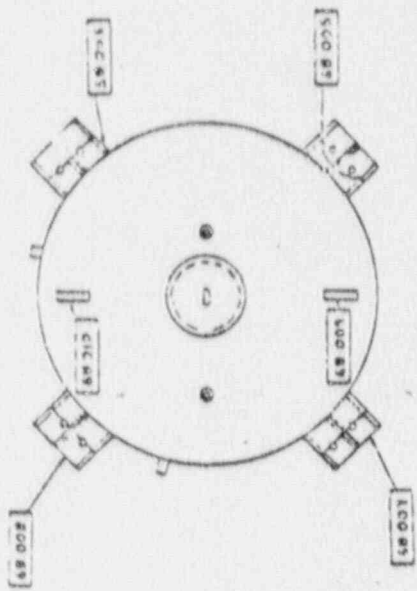


DATE	DESIGNED BY	DRN	SCALE	DATE	DESIGNED BY	DRN	SCALE
	EDWARD A. SPULT	13	1:1				
ARRAWAY POWER AND LIGHT COMPANY ARRAWAY NUCLEAR ONE U-2							
<b>SAFETY INJECTION TANK (2T28)</b> ZONE - 68							
ISI-268							0





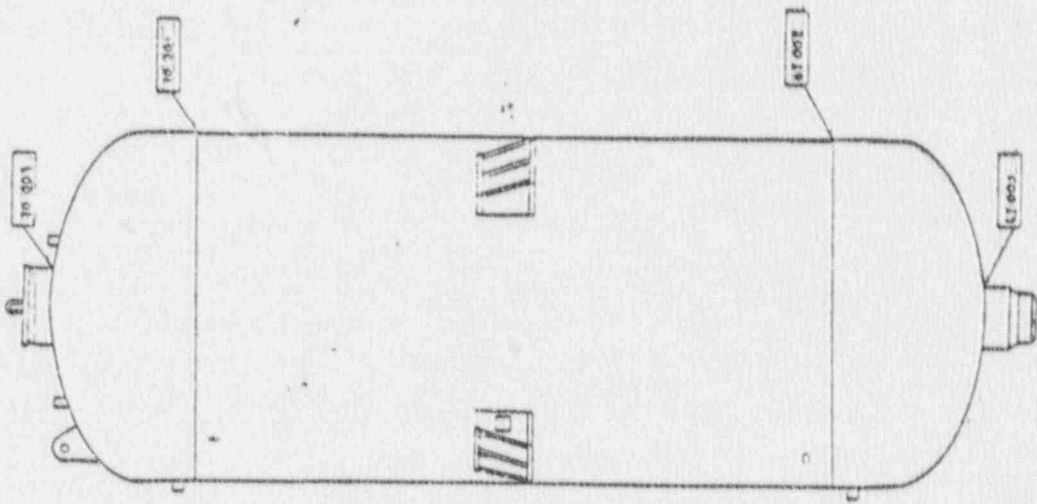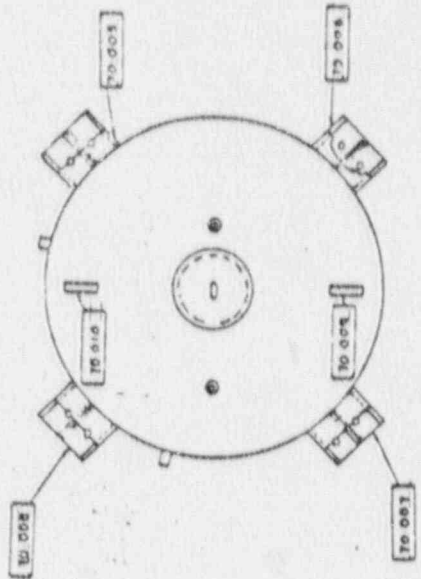


PROJECT	REVISION	DATE	BY
SCALE	DATE	BY	BY
ARKANSAS POWER AND LIGHT COMPANY ARKANSAS NUCLEAR ONE UNIT 2			
<b>SAFETY INJECTION TANK (2T20)</b> ZONE - 70			
DRAWING NO. <b>151-270</b>			SHEET NO. <b>0</b>

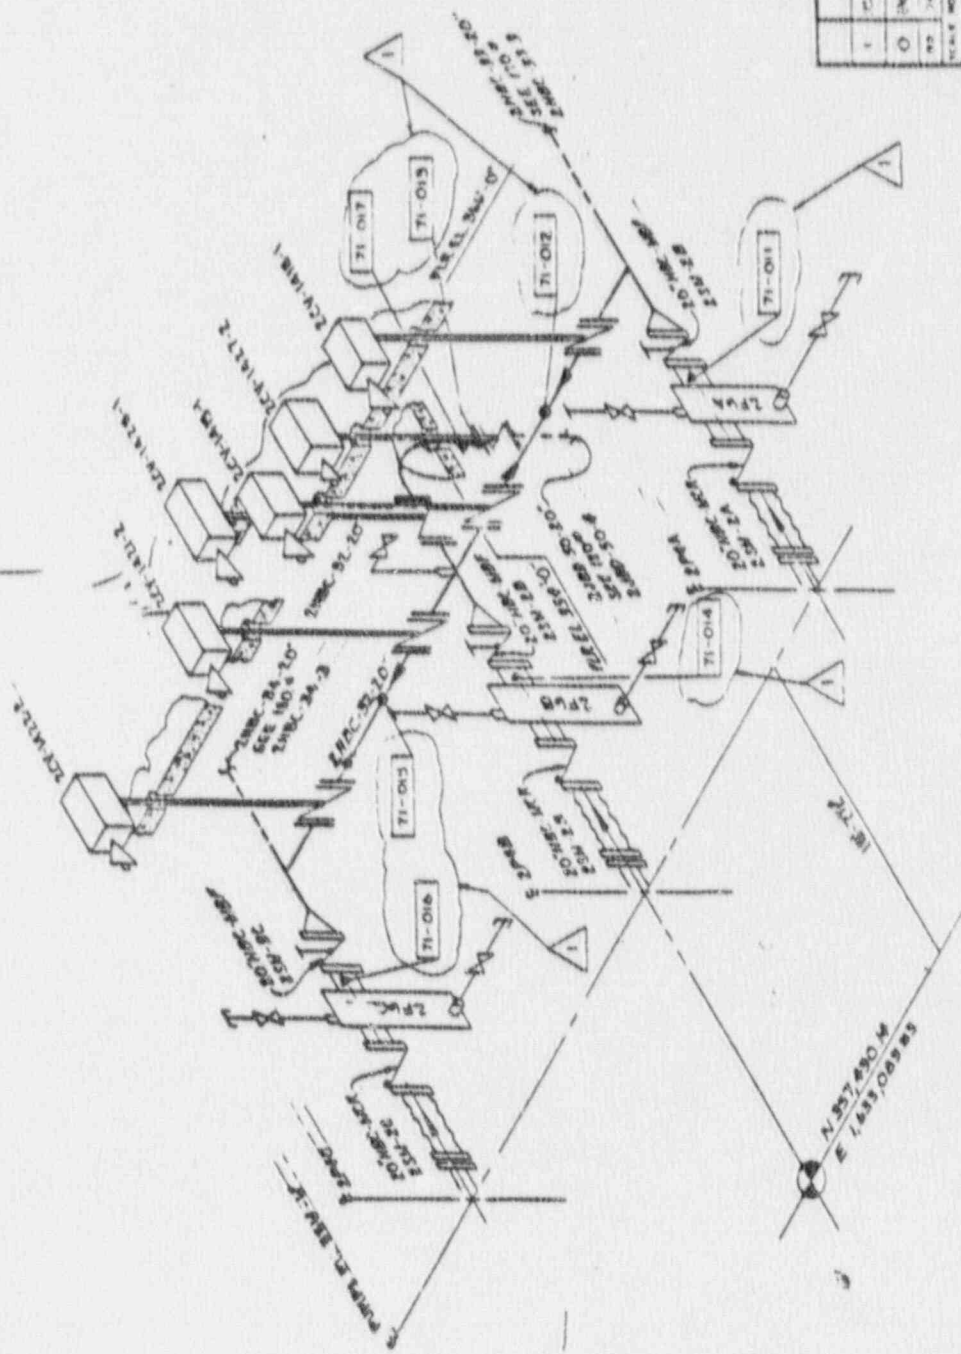








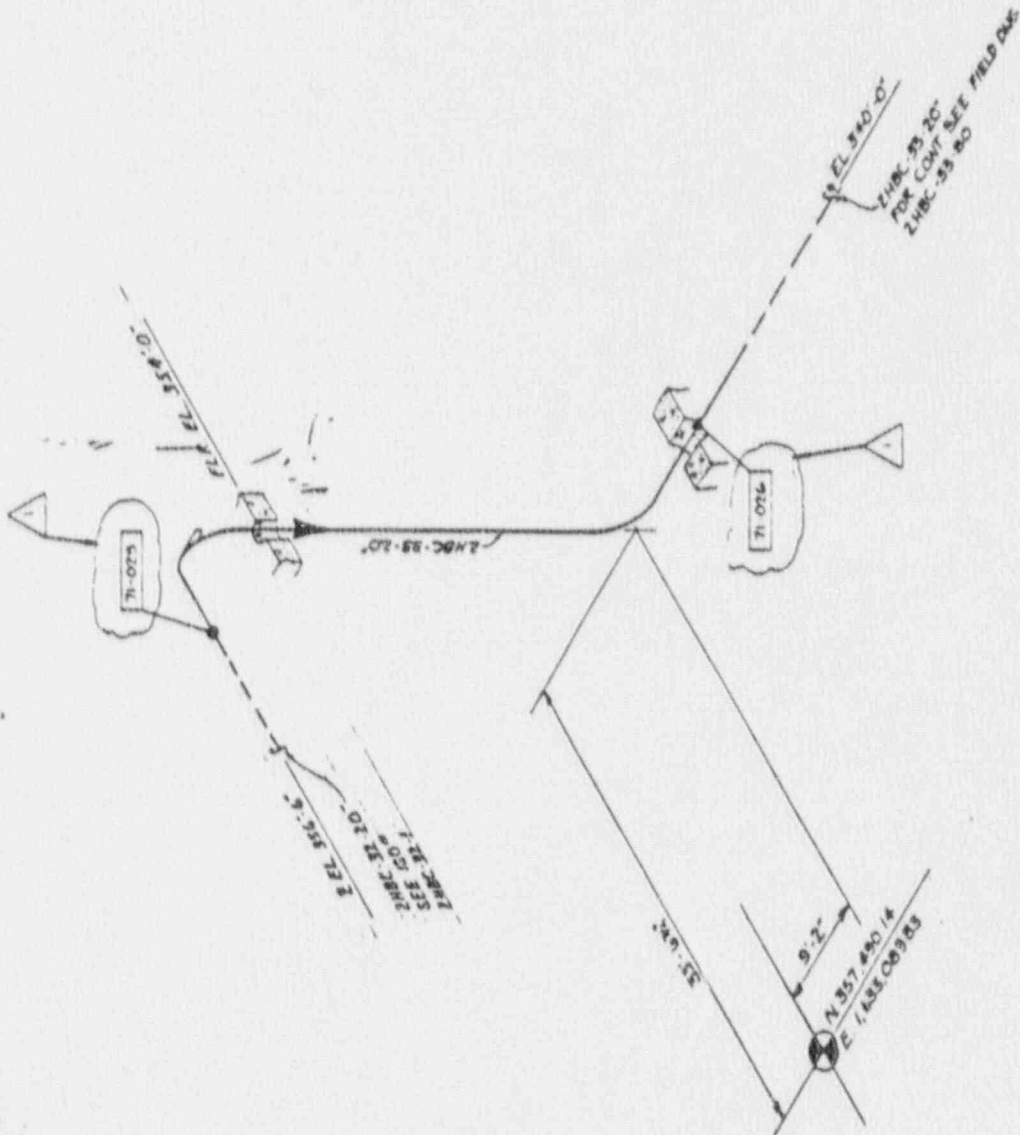

1	REVISIONS PERMIT: 15200-01000	DATE: 10/1/83
0	DESIGNED BY: PER ISI	DATE: 10/1/83
NO	REVISION	DATE
SCALE	AS SHOWN	DATE
ARKANSAS POWER AND LIGHT COMPANY ARKANSAS NUCLEAR ONE UNIT 2		
SERVICE WATER HEADER ZONE-71		
	DRAWING NO ISI-271H	SHEET NO 1



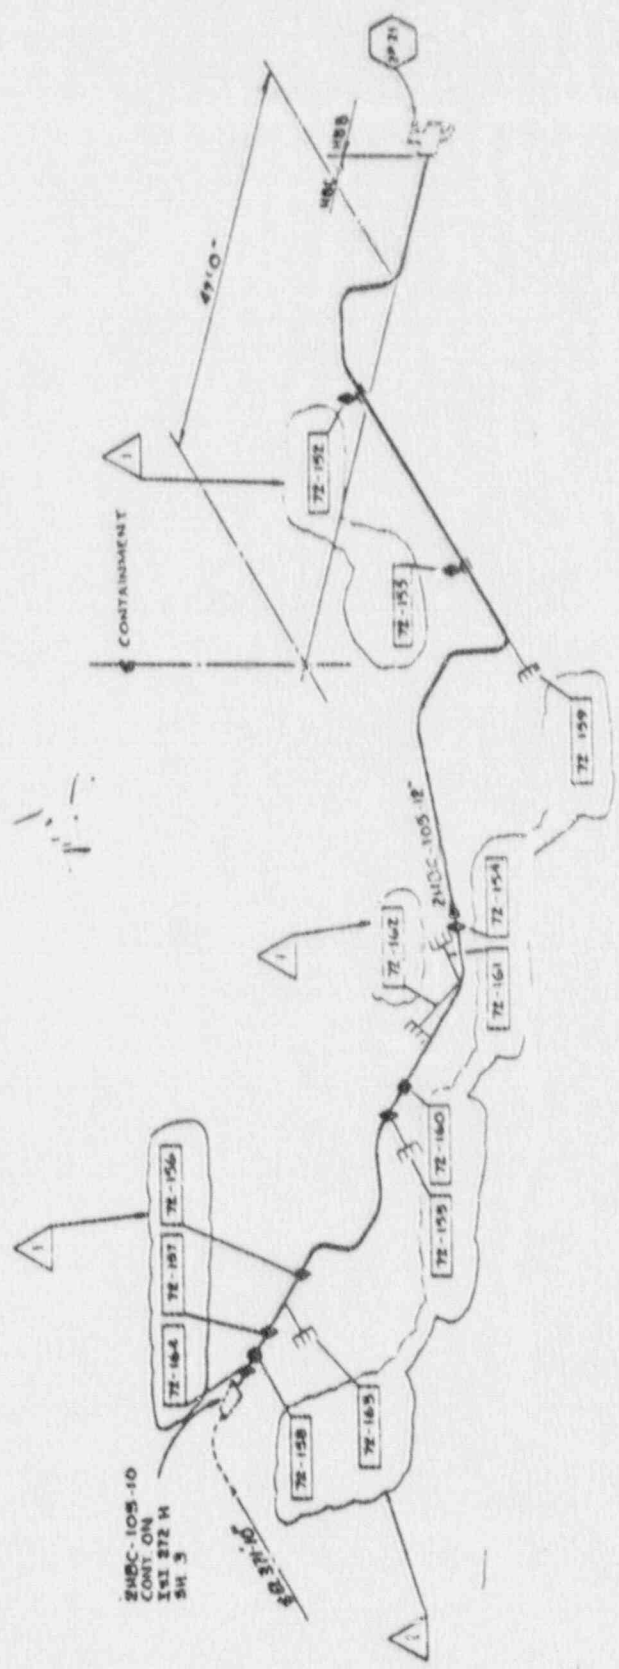

24102-105-10  
 CONT. ON  
 241 272 H  
 SH. 3

NO.	DATE	REVISION	BY	CHKD.
1	1/14/54	PEP 151	J	DP
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SERVICE WATER BRANCHES  
 ZONE - 72

24102-105-10 CONT. ON 241 272 H SH. 3	151-272H SHEET 1
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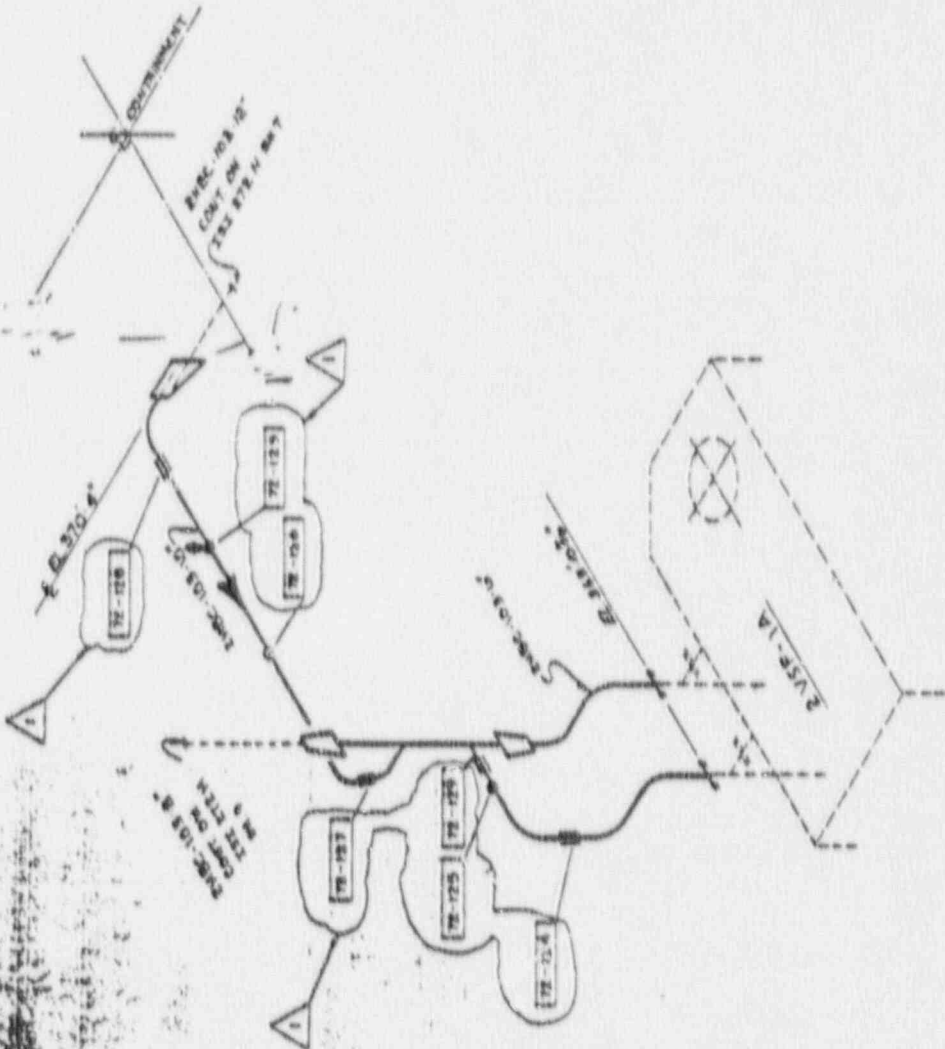













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NO	REVISED	
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ARROWAS POWER AND LIGHT COMPANY		
ARROWAS NUCLEAR ONE		
UNIT 2		
SERVICE WATER BRANCHES		
ZONE - 72		
103 272 H	1	1










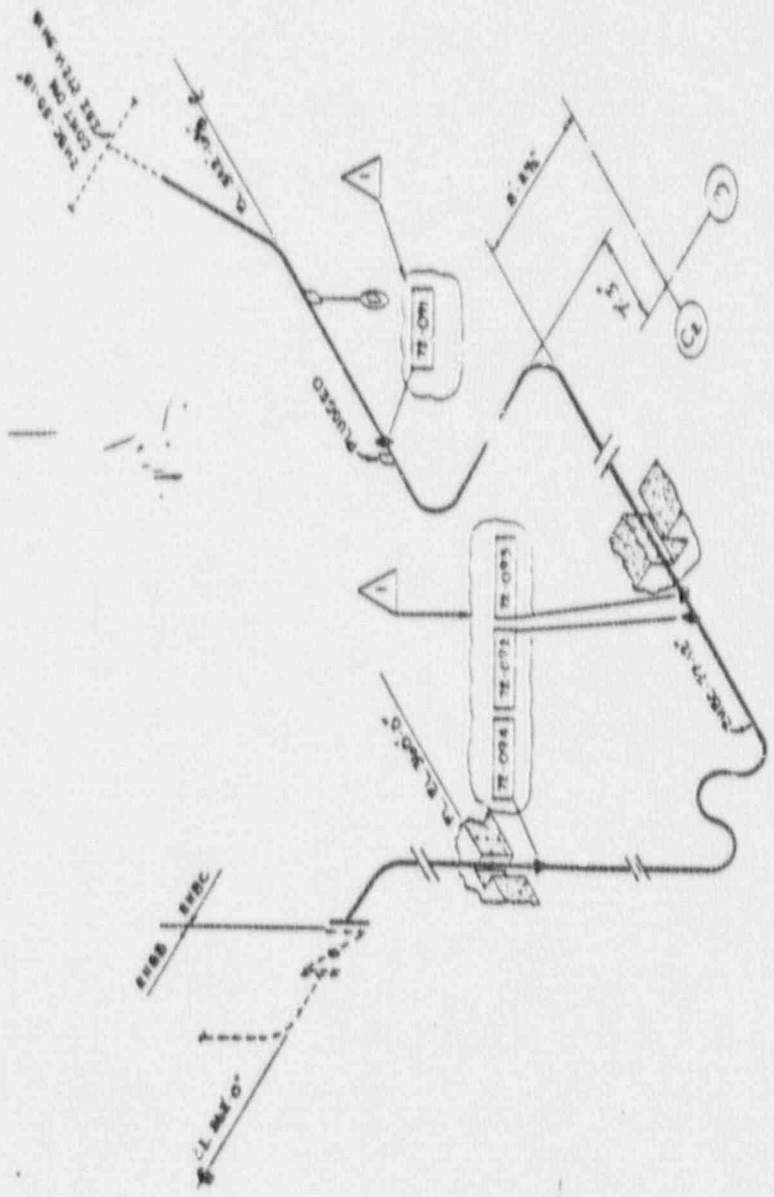

1	AS BUILT - IS (Completed)	IN 31-105
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NO	DATE	REVISION
DATE	BY	REVISION
ARKANSAS POWER AND LIGHT COMPANY ARKANSAS NUCLEAR ONE UNIT #		
<b>SERVICE WATER BRANCHES</b> <b>ZONE-72</b>		
	DRAWING NO <b>ISI-272H</b>	REV <b>1</b>

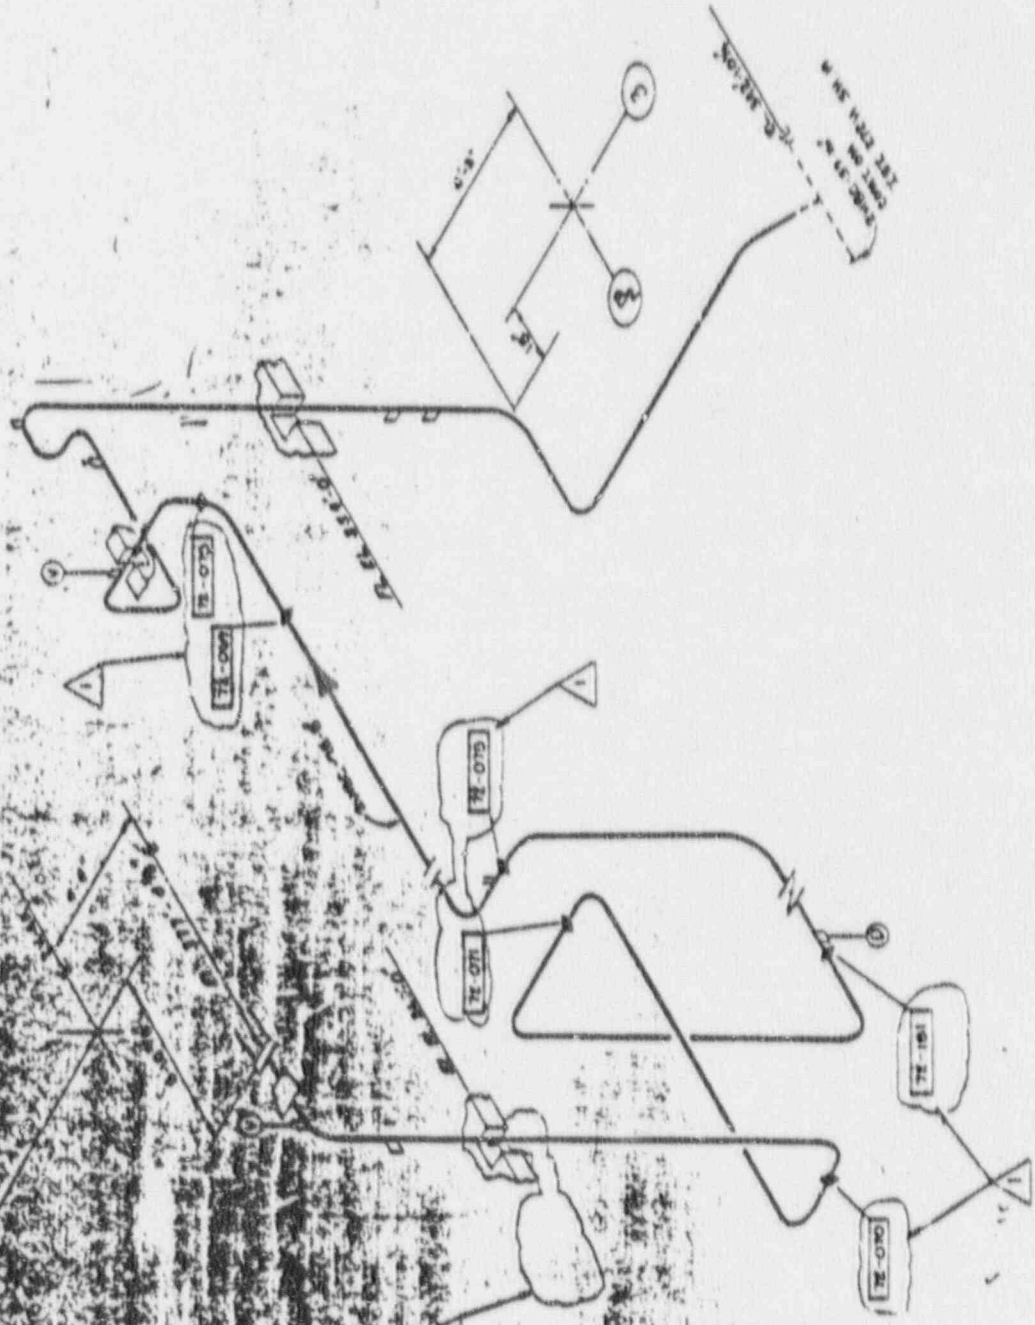

1	ISSUED FOR	DATE	BY
0	ISSUED FOR ISI	1/1/72	ISI
PROJECT: POWER AND LIGHT COMPANY			
DRAWING: MULTIPLE ONE			
SHEET: 2			
SERVICE: WATER MAINS			
ZONE: 72			
1	ISI-272H	1/1/72	1















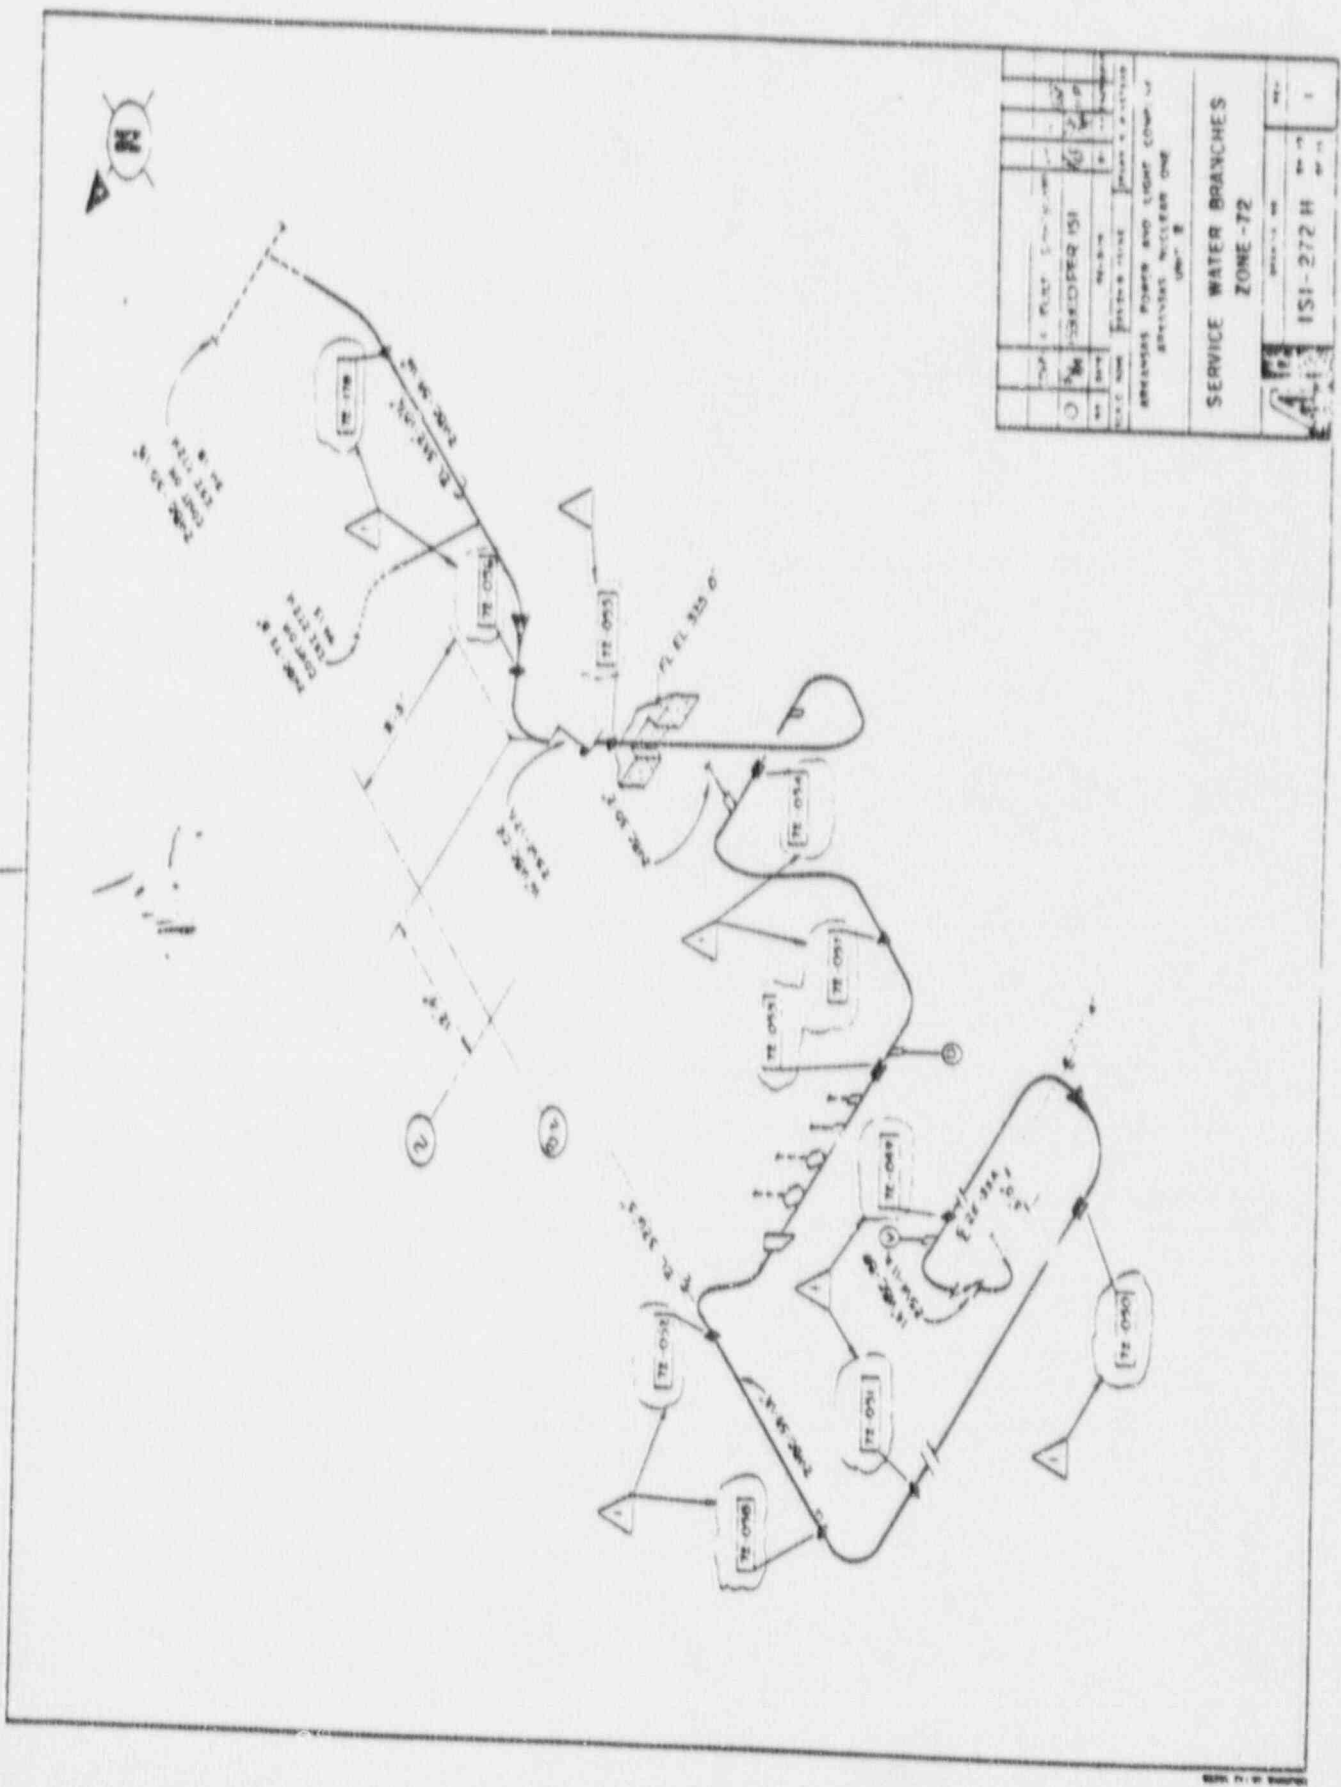

DATE	PLANT	PROJECT	SCALE
01/11/72	SI	SI	1/4" = 1'-0"
NO. 100	NO. 100	NO. 100	NO. 100
DRAWN BY: [Signature]			
CHECKED BY: [Signature]			
APPROVED BY: [Signature]			
PROJECT: SERVICE WATER AND LIGHT COMP. AT ARABIAN NUCLEAR ONE UNIT 1			
TITLE: SERVICE WATER BRANCHES ZONE-72			
NO.	REV.	DATE	BY
1		01/11/72	[Signature]



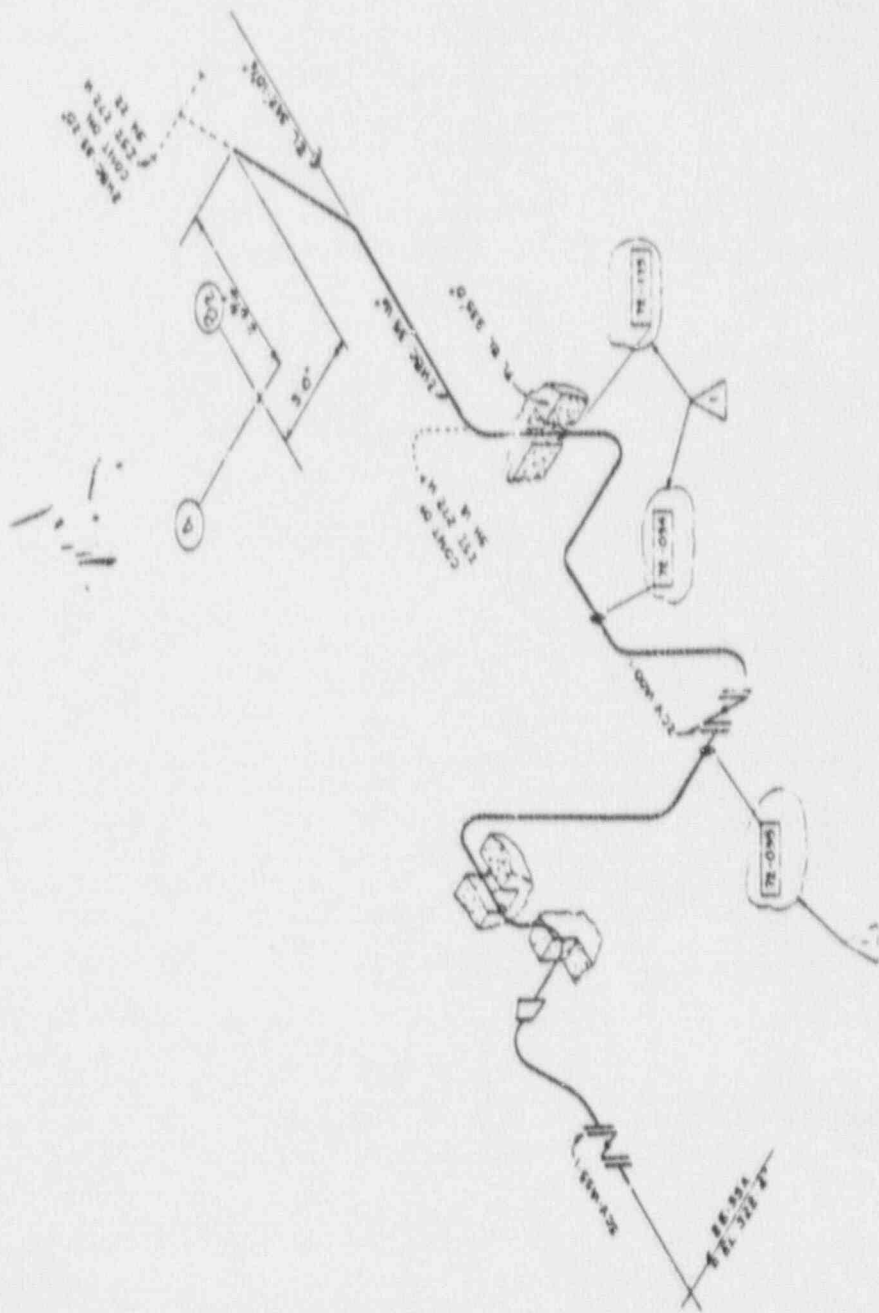

NO.	DATE	BY	REVISION	DESCRIPTION
1	10/15/72	J. W. B.		AS BUILT
2	11/15/72	J. W. B.		ADD SERVICE POINTS
3	12/15/72	J. W. B.		ADD SERVICE POINTS
4	1/15/73	J. W. B.		ADD SERVICE POINTS
5	2/15/73	J. W. B.		ADD SERVICE POINTS
6	3/15/73	J. W. B.		ADD SERVICE POINTS
7	4/15/73	J. W. B.		ADD SERVICE POINTS
8	5/15/73	J. W. B.		ADD SERVICE POINTS
9	6/15/73	J. W. B.		ADD SERVICE POINTS
10	7/15/73	J. W. B.		ADD SERVICE POINTS
11	8/15/73	J. W. B.		ADD SERVICE POINTS
12	9/15/73	J. W. B.		ADD SERVICE POINTS
13	10/15/73	J. W. B.		ADD SERVICE POINTS
14	11/15/73	J. W. B.		ADD SERVICE POINTS
15	12/15/73	J. W. B.		ADD SERVICE POINTS
16	1/15/74	J. W. B.		ADD SERVICE POINTS
17	2/15/74	J. W. B.		ADD SERVICE POINTS
18	3/15/74	J. W. B.		ADD SERVICE POINTS
19	4/15/74	J. W. B.		ADD SERVICE POINTS
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21	6/15/74	J. W. B.		ADD SERVICE POINTS
22	7/15/74	J. W. B.		ADD SERVICE POINTS
23	8/15/74	J. W. B.		ADD SERVICE POINTS
24	9/15/74	J. W. B.		ADD SERVICE POINTS
25	10/15/74	J. W. B.		ADD SERVICE POINTS
26	11/15/74	J. W. B.		ADD SERVICE POINTS
27	12/15/74	J. W. B.		ADD SERVICE POINTS
28	1/15/75	J. W. B.		ADD SERVICE POINTS
29	2/15/75	J. W. B.		ADD SERVICE POINTS
30	3/15/75	J. W. B.		ADD SERVICE POINTS
31	4/15/75	J. W. B.		ADD SERVICE POINTS
32	5/15/75	J. W. B.		ADD SERVICE POINTS
33	6/15/75	J. W. B.		ADD SERVICE POINTS
34	7/15/75	J. W. B.		ADD SERVICE POINTS
35	8/15/75	J. W. B.		ADD SERVICE POINTS
36	9/15/75	J. W. B.		ADD SERVICE POINTS
37	10/15/75	J. W. B.		ADD SERVICE POINTS
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39	12/15/75	J. W. B.		ADD SERVICE POINTS
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41	2/15/76	J. W. B.		ADD SERVICE POINTS
42	3/15/76	J. W. B.		ADD SERVICE POINTS
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96	9/15/80	J. W. B.		ADD SERVICE POINTS
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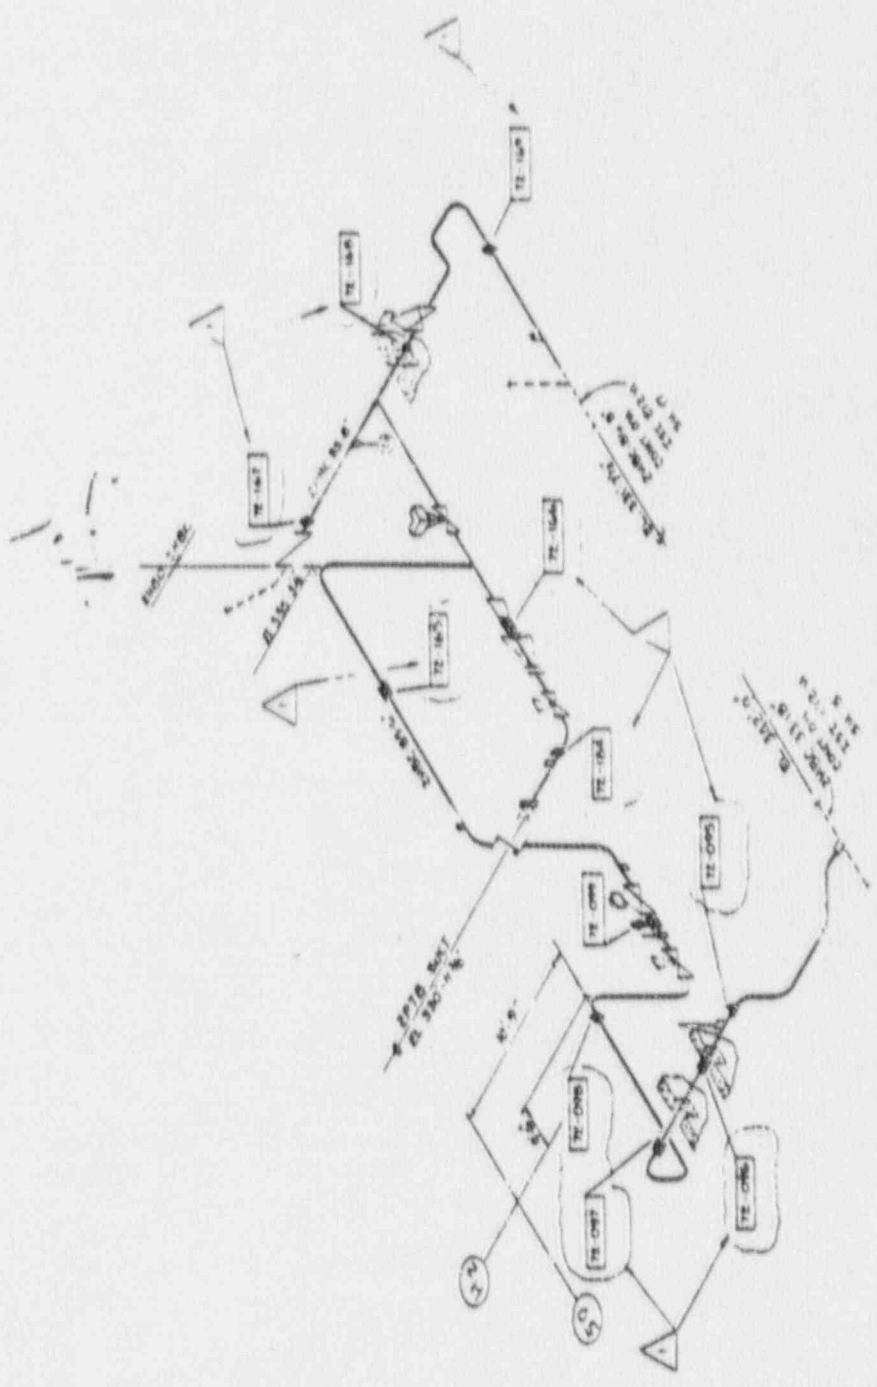
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SERVICE WATER BRANCHES  
ZONE-72

ISI - 272H  
1









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ARKANSAS NUCLEAR ONE			
UNIT 2			
SERVICE WATER BRANCHES			
ZONE 72			
NO.	11-272H	REV.	1






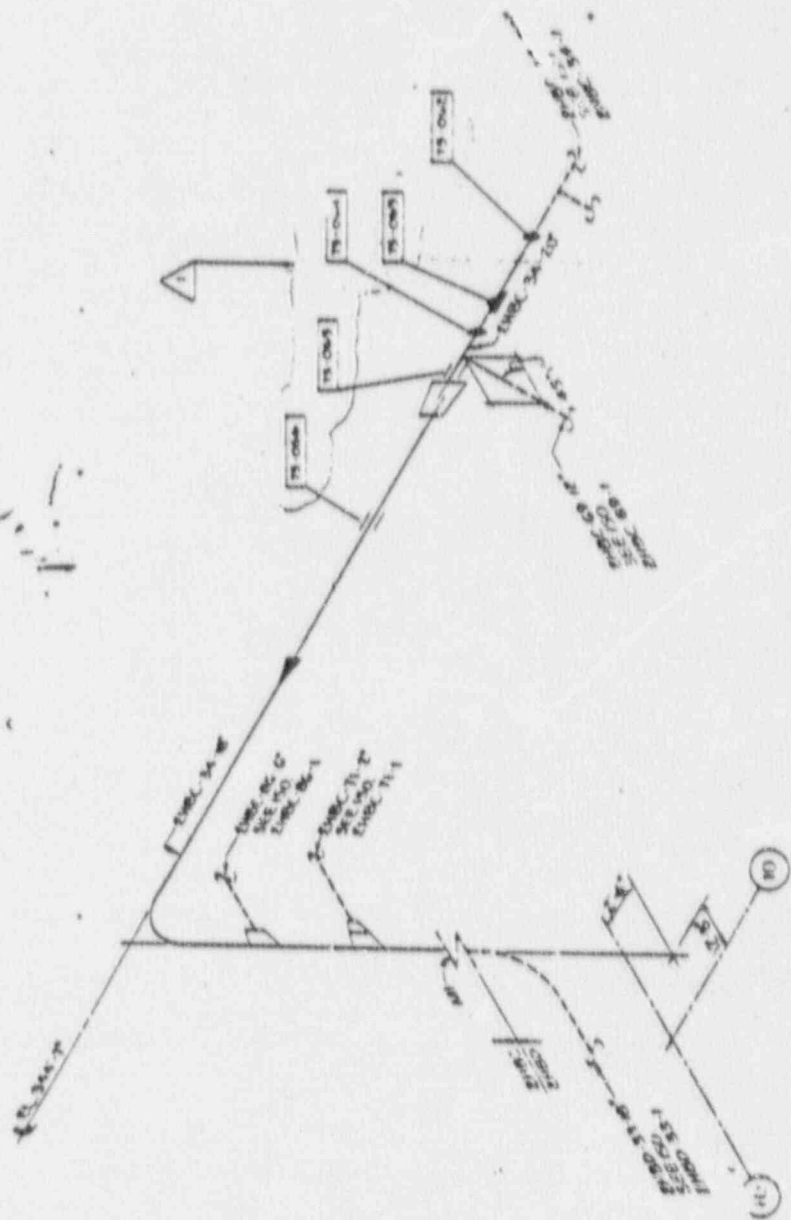

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PROJECT NO. 151-273H		DRAWN BY [Signature]	
CHECKED BY [Signature]		SCALE 1" = 100'	
SPRINGFIELD POWER AND LIGHT COMPANY			
BRATTLEBORO NUCLEAR ONE			
UNIT 2			
SERVICE WATER HEAD "B"			
ZONE - 73			
DATE OF REV. 1-25-68			
BY [Signature]			
151-273H			

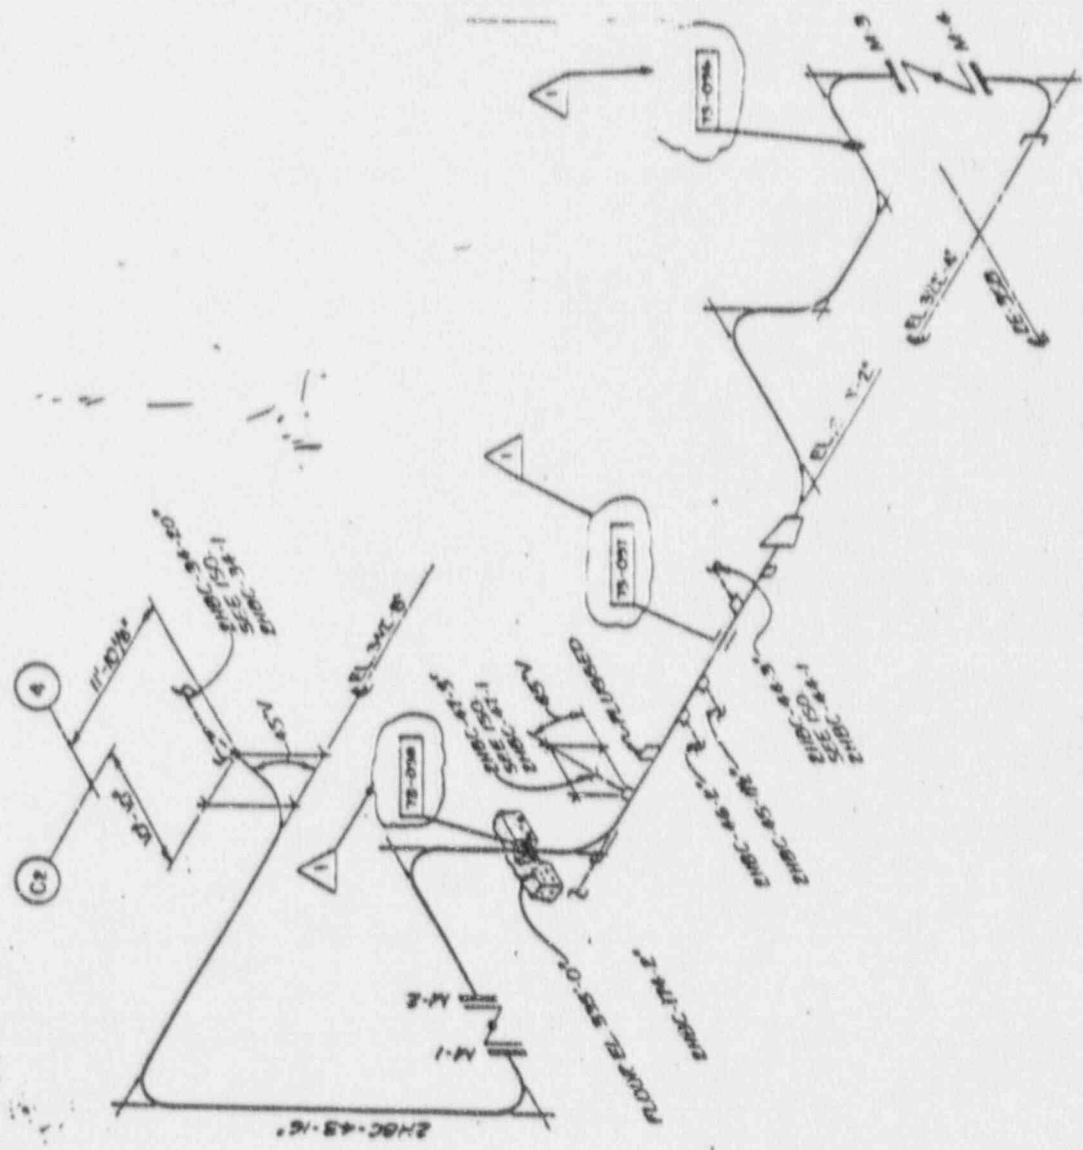

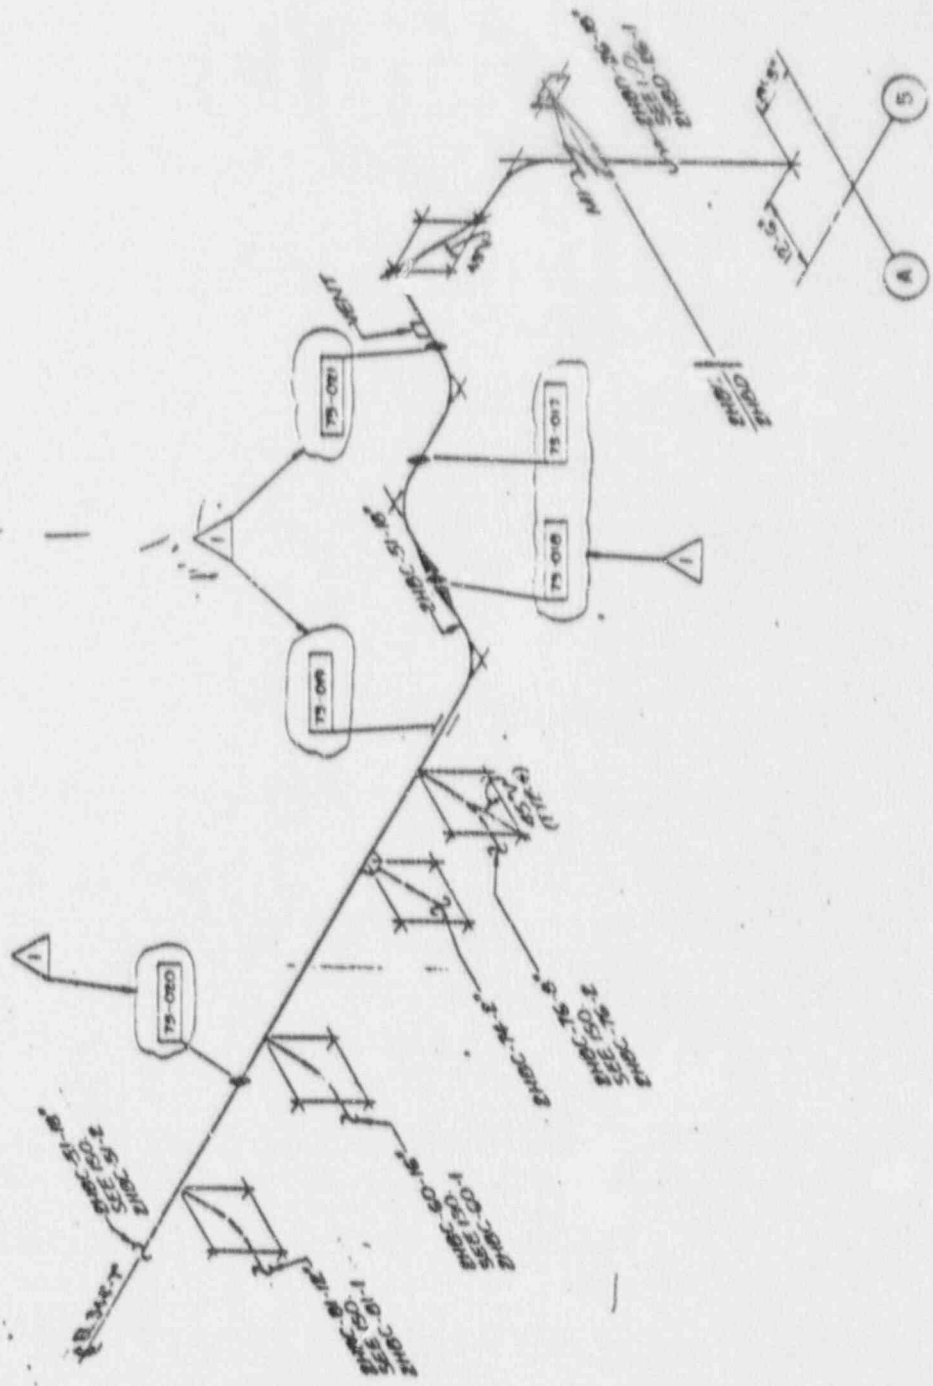


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DESIGNED BY: PERI ISI	SCALE: AS SHOWN
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ISSUE NO.	REV. 1
ISI-273H	1









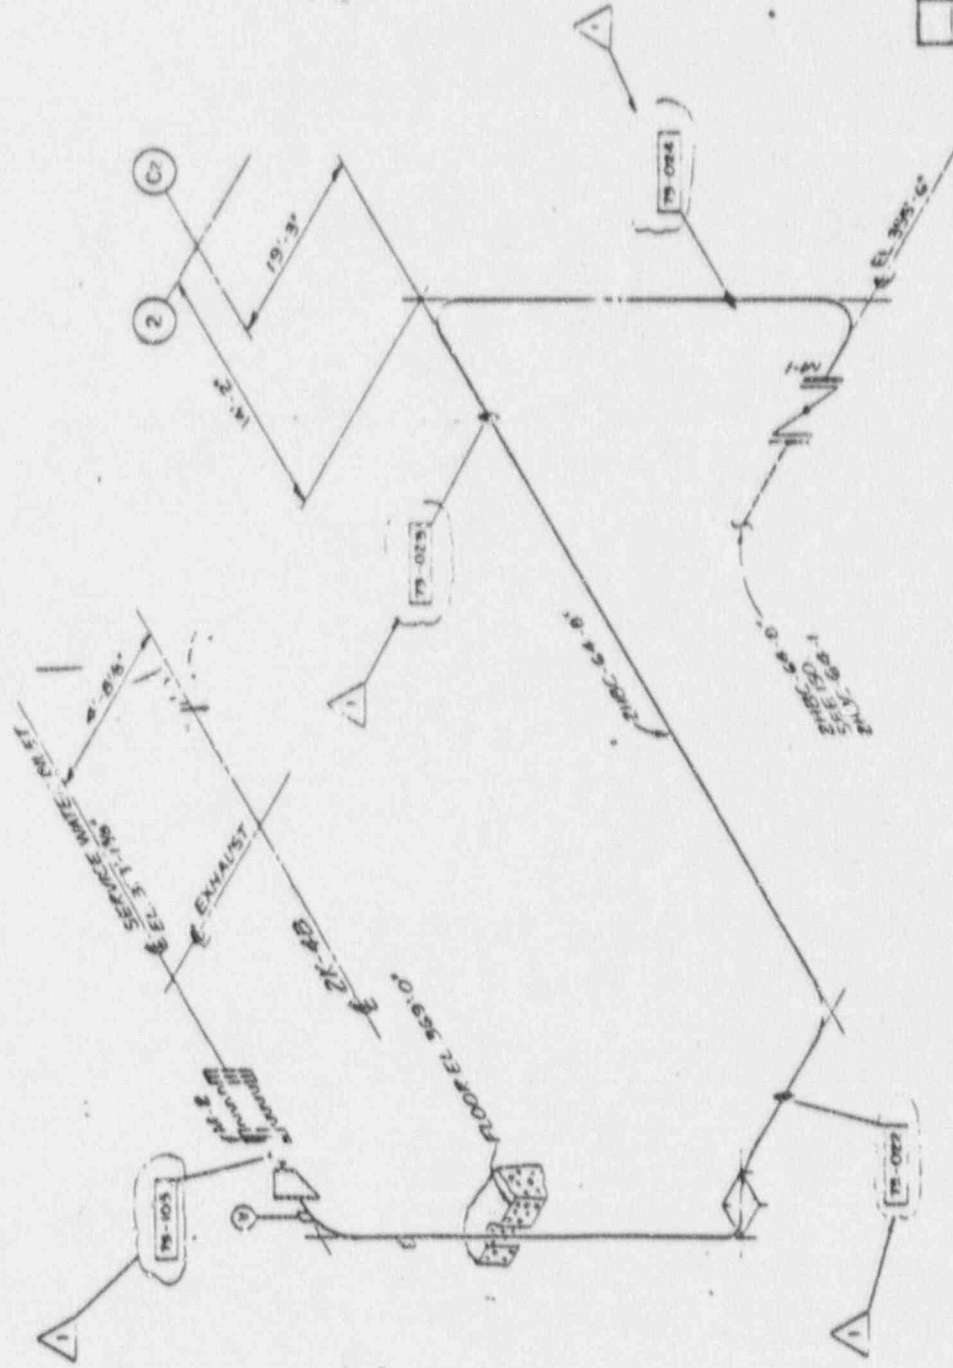


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99	APPROX. BUILT	1950	APPROX. BUILT	1950
100	APPROX. BUILT	1950	APPROX. BUILT	1950

AP  
SERVICE WATER HEADER  
ZONE - 73  
ISI-27'H





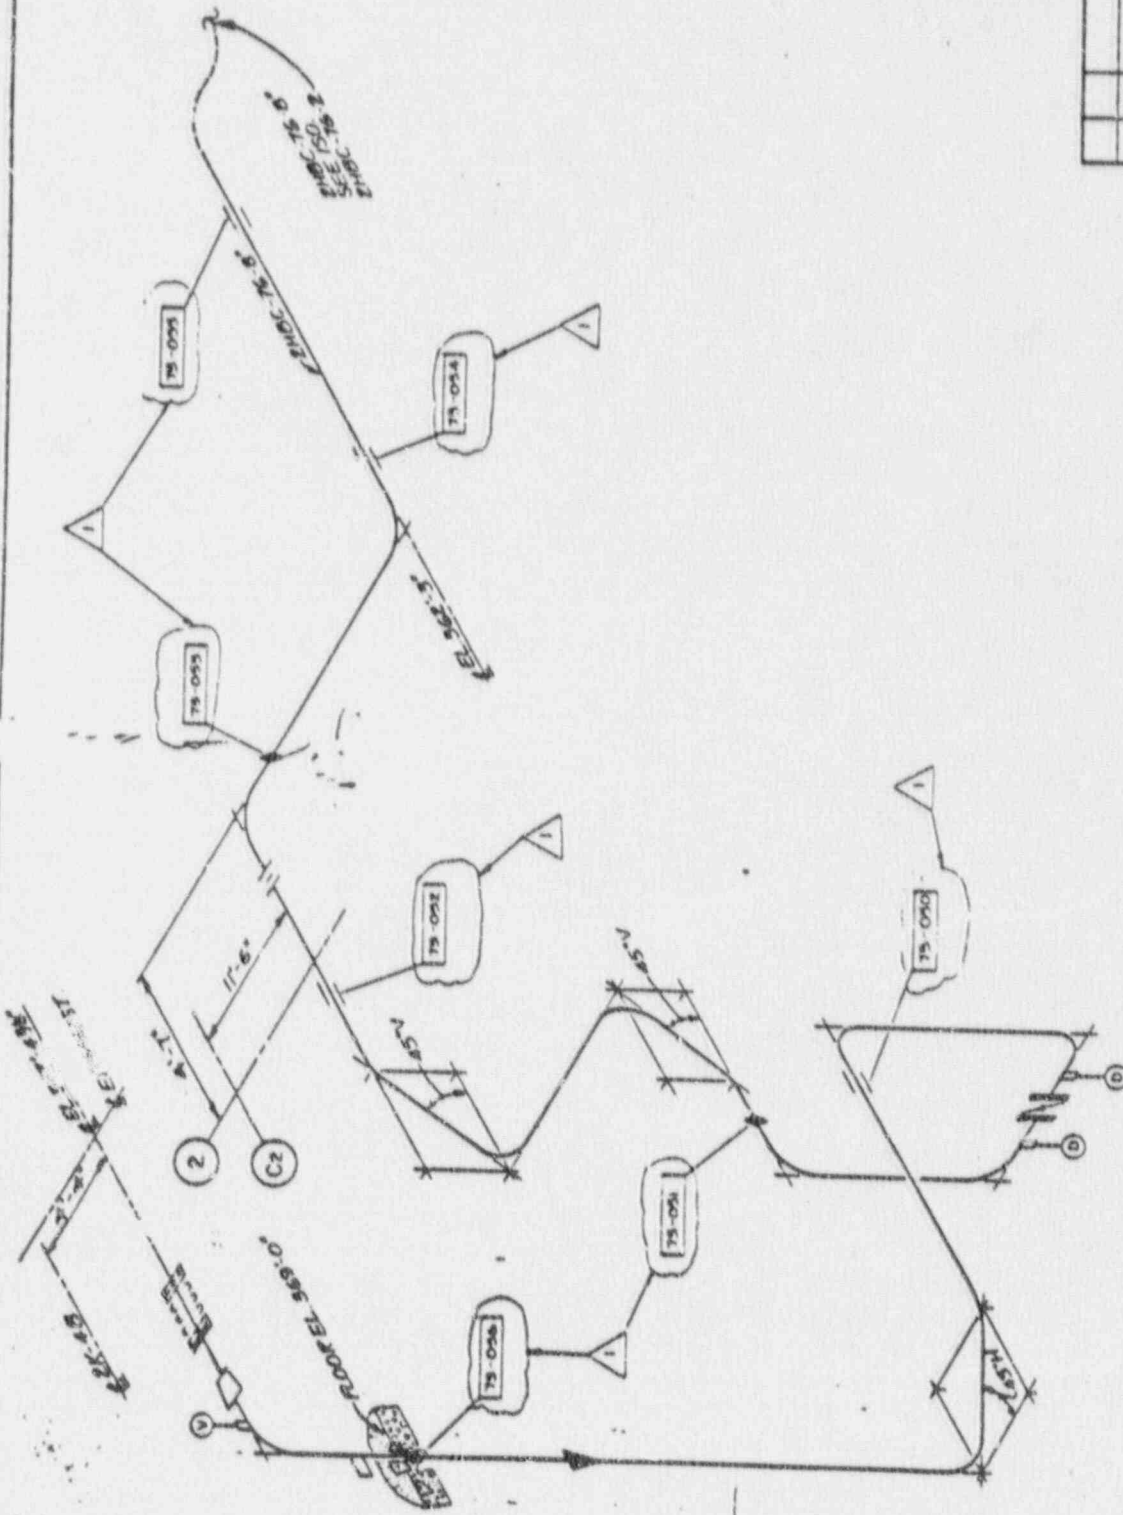


1	REV	AS BUILT: SEPT-2006	AS E
0	ISSUED FOR ISI	000	
NO	REV	REVISION	BY
DATE	ISSUED	BY	DATE
ARLUNDAS POWER AND LIGHT COMPANY ARLUNDAS 1 NUCLEAR ONE UNIT 2			
SERVICE WATER HEADER ZONE - 73			
SCALE: AS SHOWN			
DRAWING NO. ISI-273H			








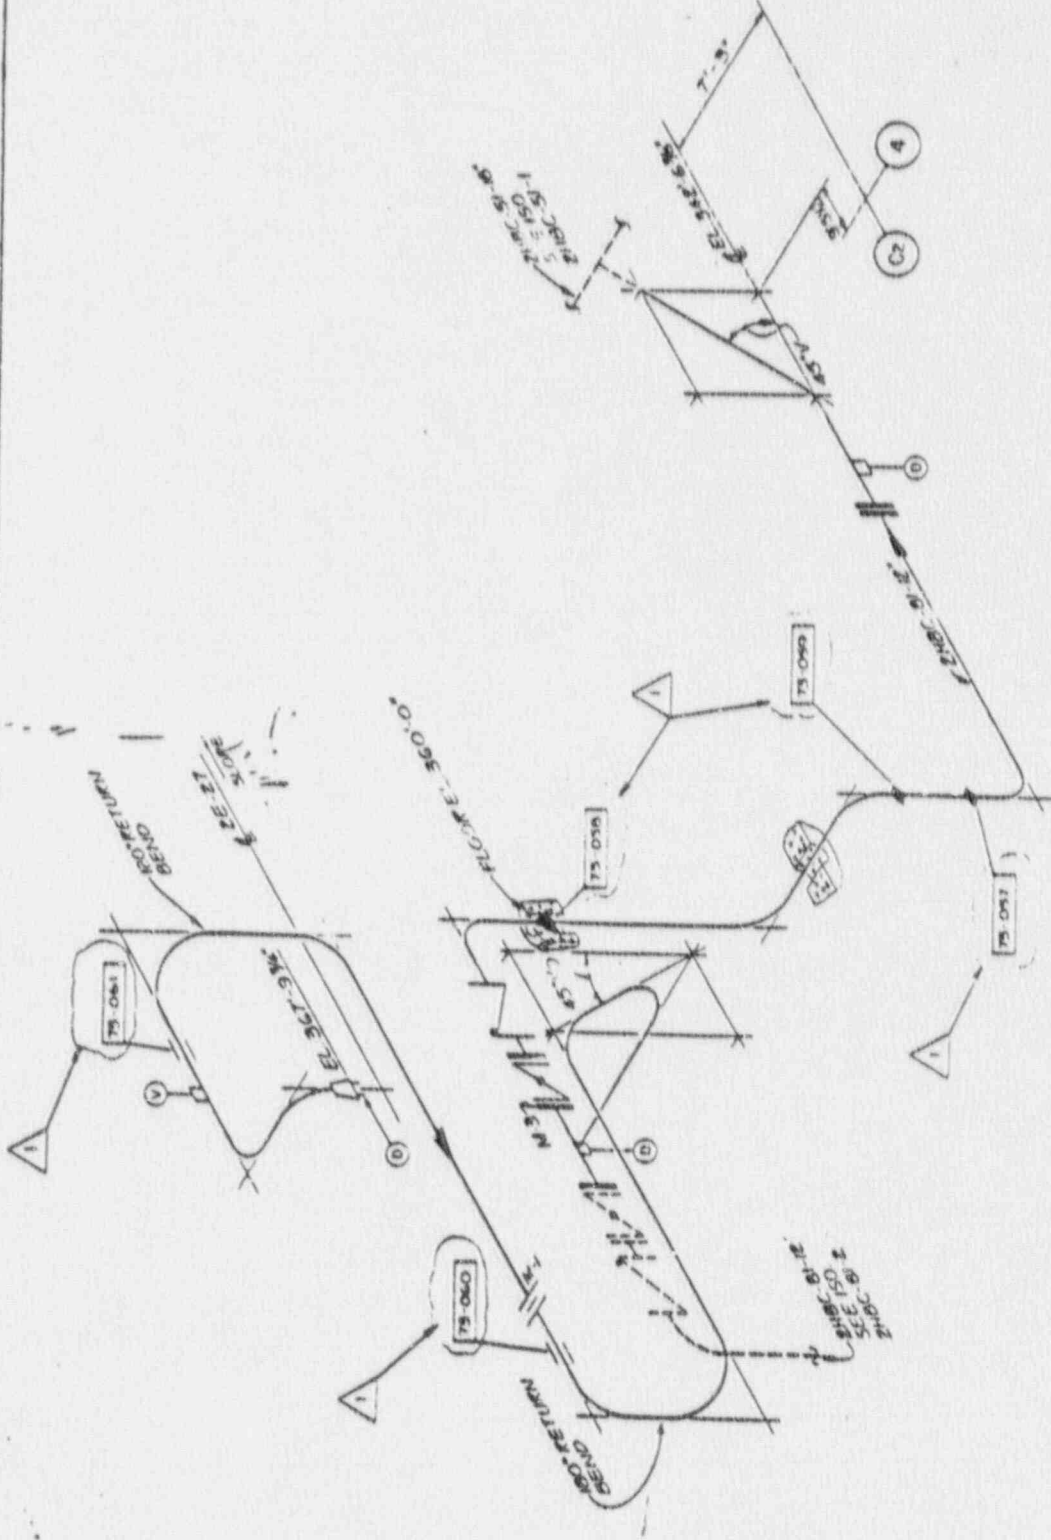

1	TS-0100	TS-0106	TS-0109	TS-0107
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SERVICE WATER HEADER ZONE - 73				
PROJECT NO. ISI-273H				SHEET NO. 10






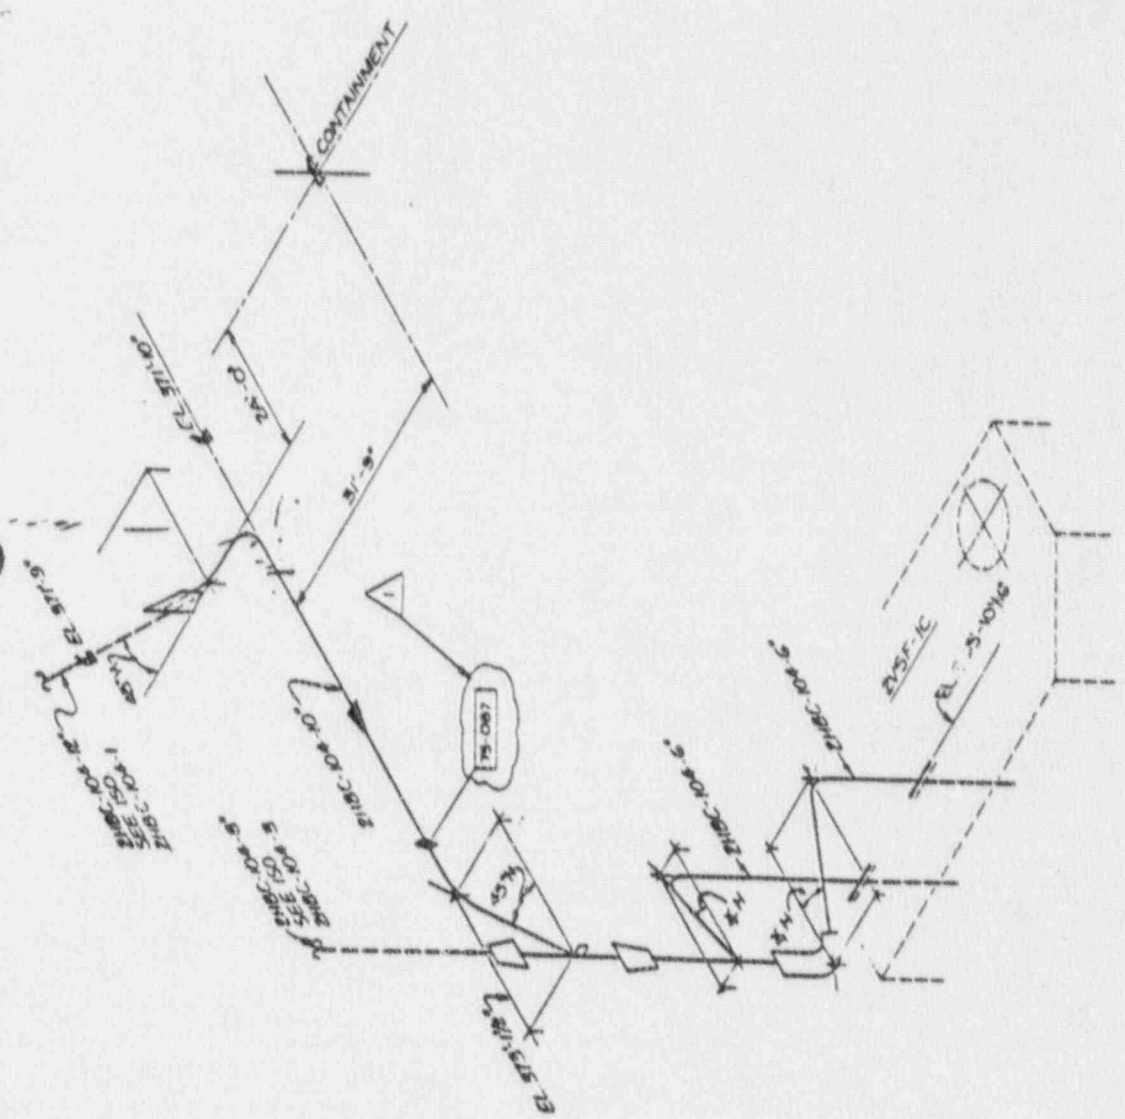

1	REV	AS BUILT (DATE: 04/08)	BY	AK
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NO	DATE	REVISION	BY	DATE
SCALE	AS SHOWN	PROJECT NO.	1	1
ARKANSAS POWER AND LIGHT COMPANY ARKANSAS NUCLEAR ONE UNIT 2				
SERVICE WATER HEADER ZONE - 7J				
PROJECT NO.			ISI-273H	REV.
			04-0	1





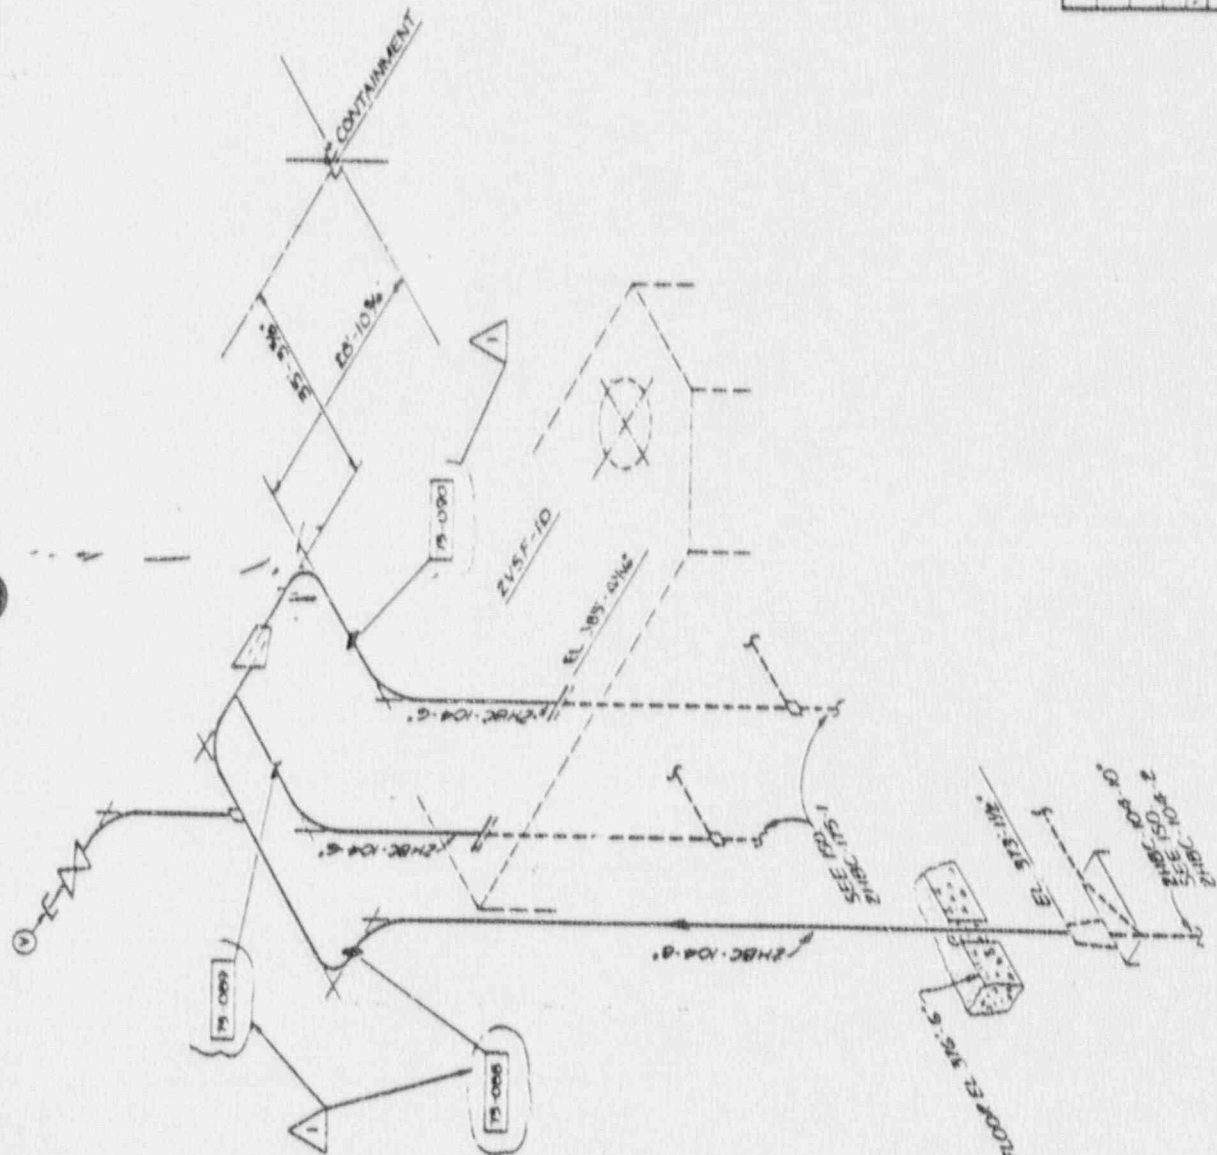


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BRANKS POWER AND LIGHT ELEMENT  
BRANKS NUCLEAR ONE  
UNIT 2

SERVICE WATER HEADER  
ZONE - 73

DATE: 12/27/71

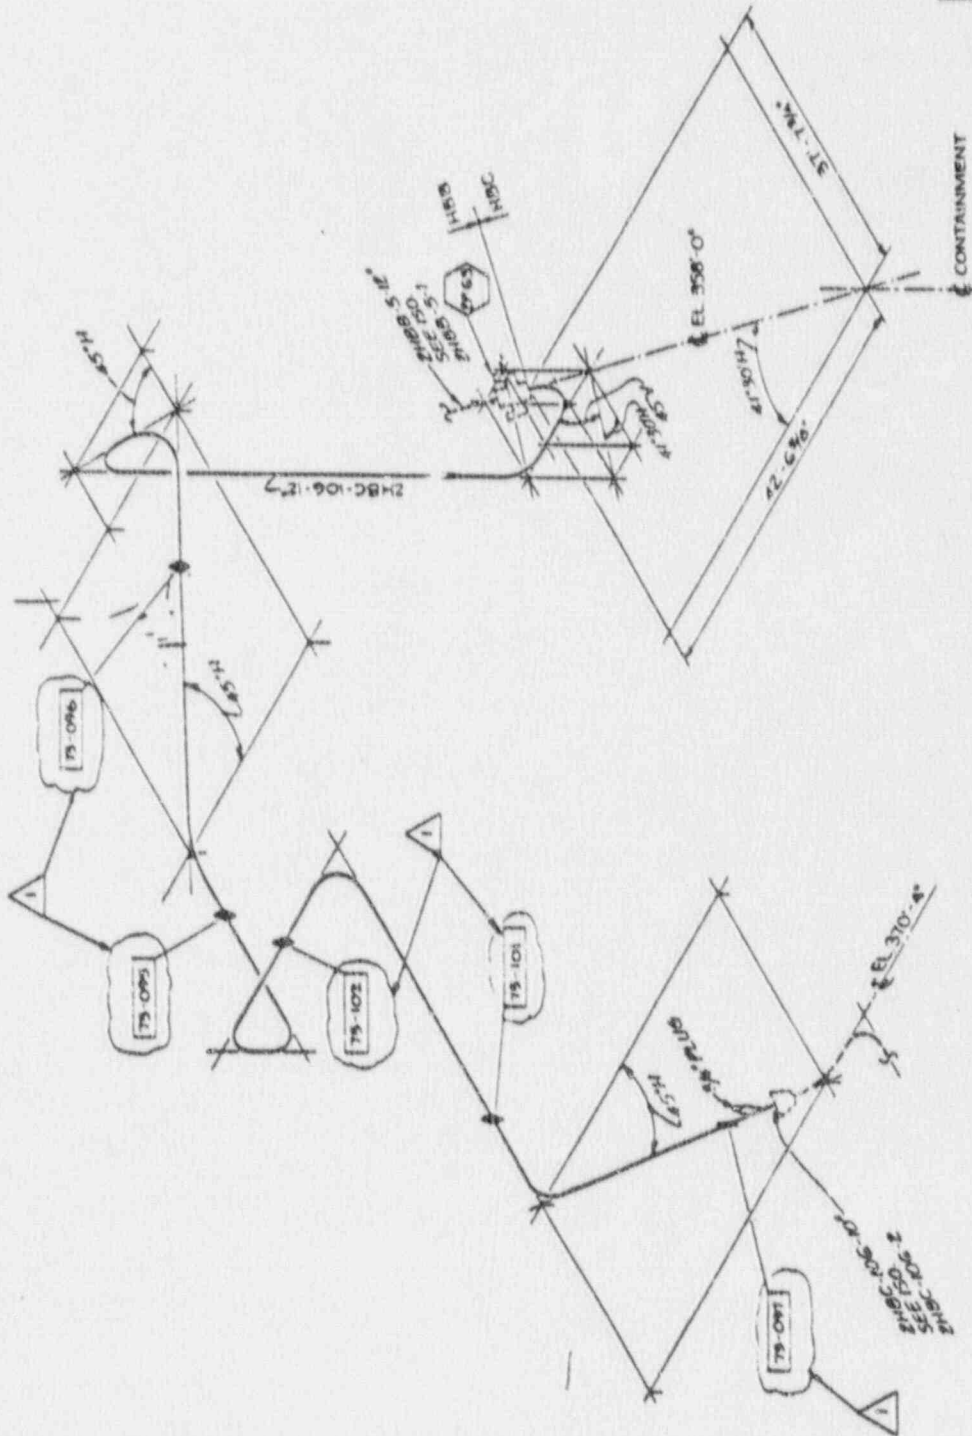

1	ASME B31.1	CLASSIFICATION	CLASSIFICATION
0	ASME B31.1	ISSUED PER ISI	NO. OF ISSUES
NO	DATE	REVISION	BY
1	10/10/73	ISSUED PER ISI	NO. OF ISSUES
ARKANSAS POWER AND LIGHT CO. - SRY BIRKBECK NUCLEAR ONE UNIT 2			
SERVICE WATER HEADER ZONE - 73			
DRAWING NO. ISI-273H		SHEET NO. 1	




















109 L.F

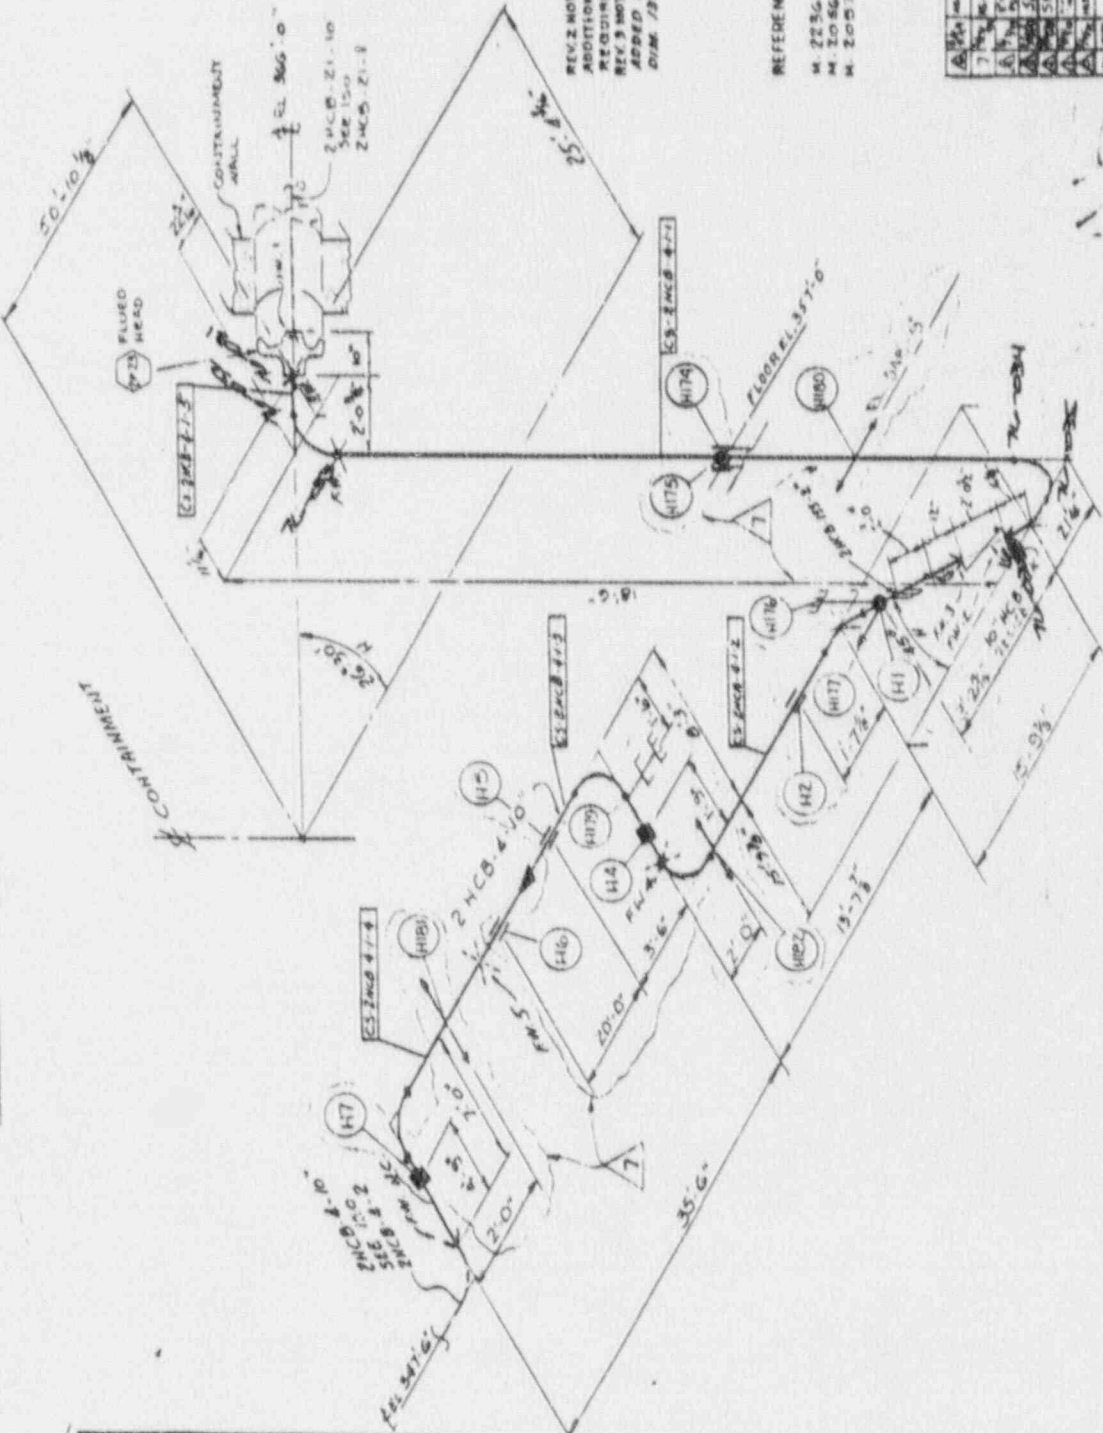

REV 2 NOTE. P.W. AND SPOOL W/ ADDITIONAL REQUIRED DUE TO FLOOR  
REV 3 NOTE. ADDED P.W. AND SPOOL W/ CS 2 HCB-4-1-5. DIM. 131 7/8" WIDE 13-7/8"

REFERENCE DRAWINGS  
M. 2256 REV 14 P4 10  
M. 2056 - 2D PIPING PLAN AREA 2C  
M. 2057 - 37

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**BECHTEL**  
SAN FRANCISCO

AREAS POWER & LIGHT COMPANY  
ARMSTRONG BRICKLAR ONE  
BOST 2

ISOMETRIC - CONTAINMENT B-DG  
CONTAINMENT SPRAY

6600-2 ZHC0-4-1-7

17822

- 1 PIPE SPOOL CS-2HCB-4-11
- 2 CS-2HCB-4-12
- 3 CS-2HCB-4-13
- 4 CS-2HCB-4-14
- 5 VALVE 10" HCB-CX
- 6 PIPE SPOOL CS-2HCB-4-1-5

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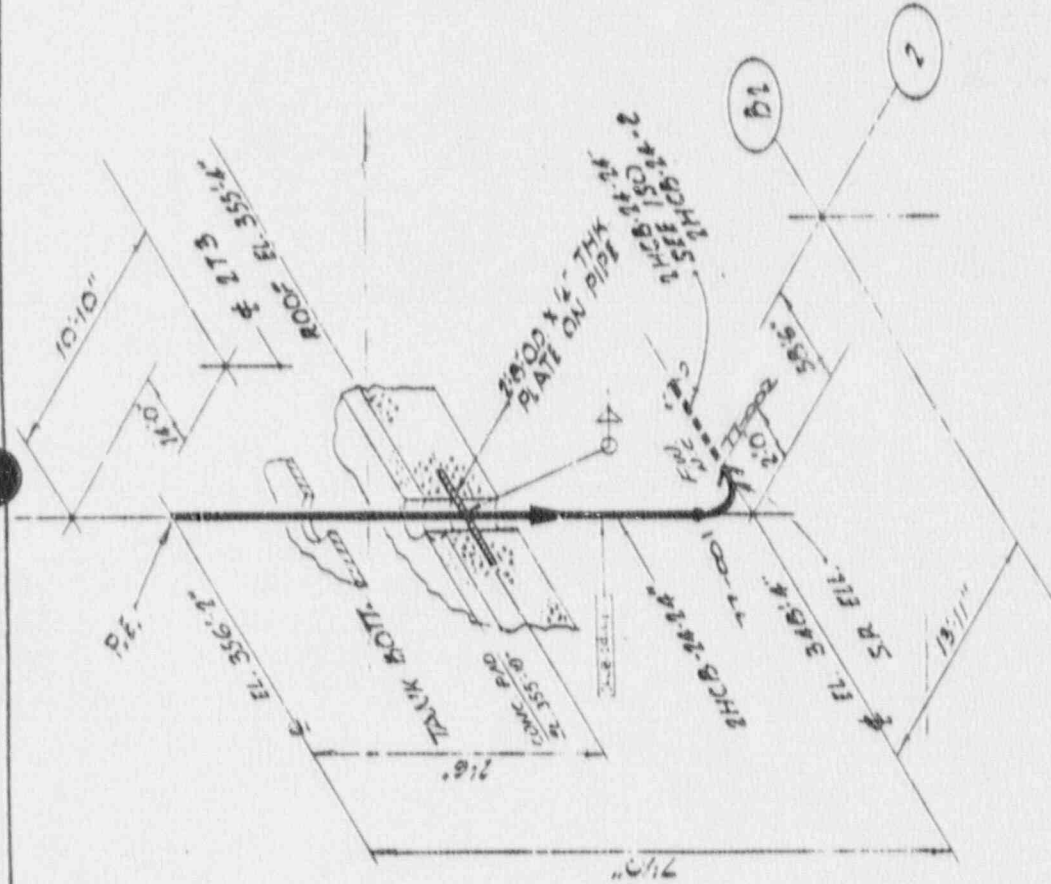


11 LIN. 77.



REV. DATE  
APPRO. SHEET NO.  
APPRO. NAME (DATE)  
SCALE 1/8" = 1'-0"  
SHEET NO. 1 OF 1

REFERENCE DRAWINGS  
M-1136 REF. P.M.D.  
M-1064 " " PIPING PLAN AREA 16



NO.	DATE	DESCRIPTION	BY	CHKD.
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BECHTEL  
SAN FRANCISCO  
ARKANSAS POWER & LIGHT COMPANY  
ARKANSAS NUCLEAR ONE  
UNIT 2

ISOMETRIC CONTAINMENT AUX. BLDG.  
CONTAINMENT SPRAY

ISI-277


NO.	DATE	DESCRIPTION	BY	CHKD.
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I certify that the image contained on this frame was made in the normal and regular course of business, on the date stated below and that it is an accurate reproduction of the document submitted to me.

1-6 X





REFERENCE DRAWINGS  
 M-2236 REV. 1/19/60  
 M-2044 \* 9 PIPING PLAN ARE-25

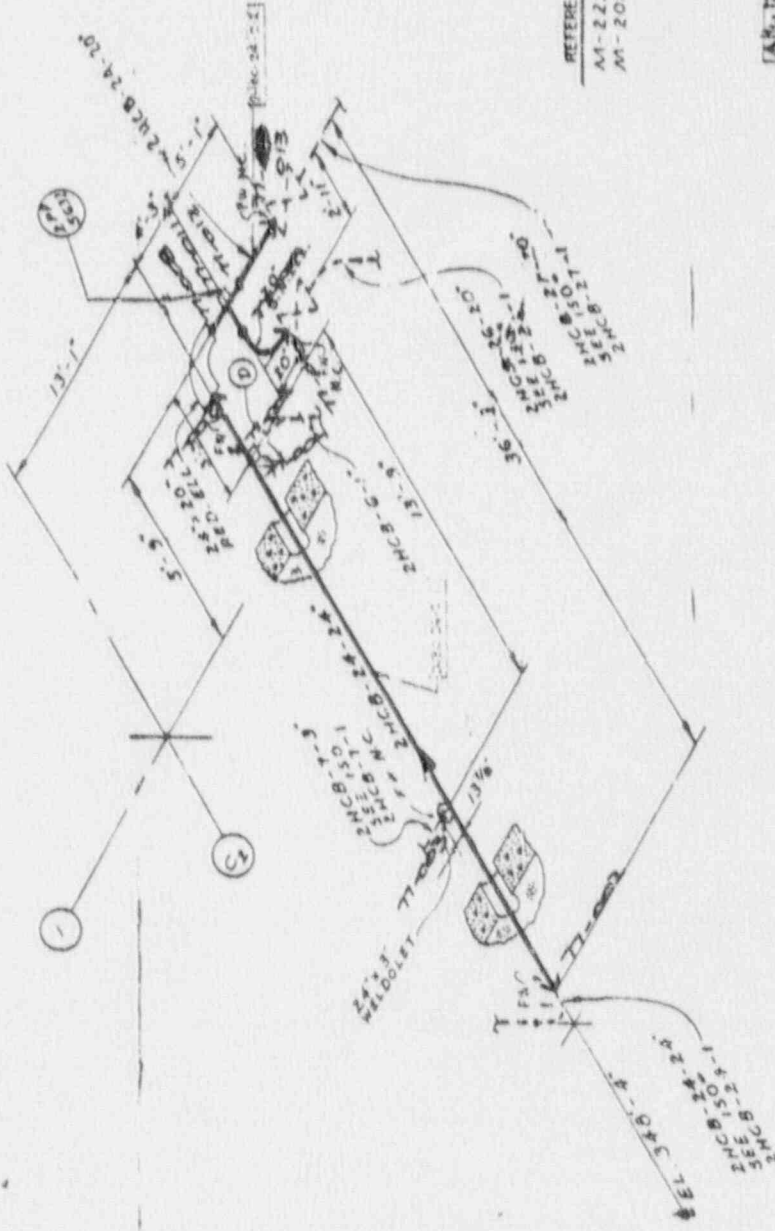- 1. 4\"/>

ISI-277

NO.	DATE	DESCRIPTION	BY	CHECKED
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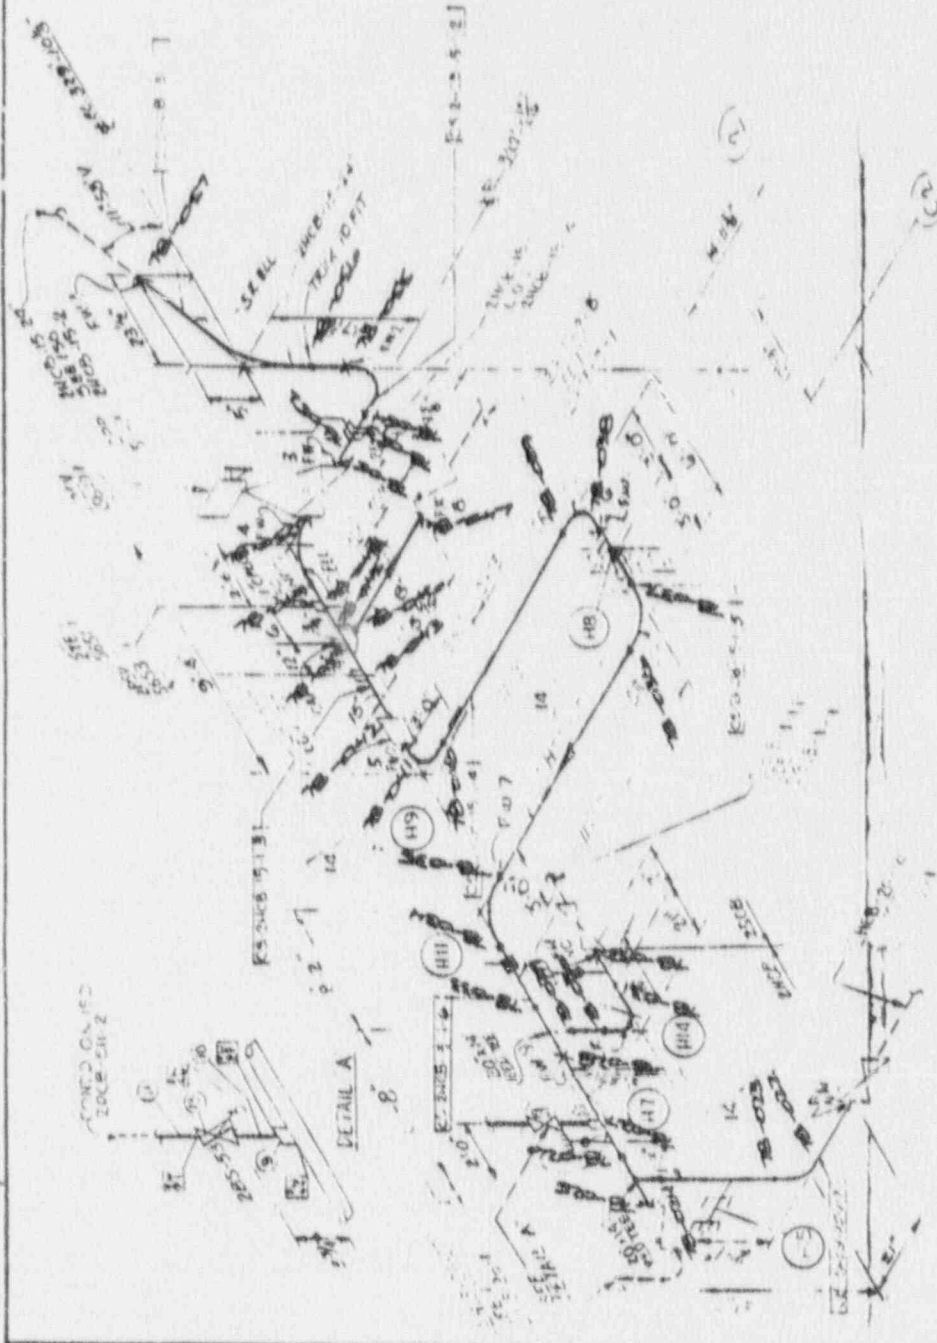
**BECHTEL**  
 SAN FRANCISCO  
 ARKANSAS POWER & LIGHT COMPANY  
 ARKANSAS NUCLEAR ONE  
 UNIT 2  
 ISOMETRIC-CONTAINMENT AUX BIDS  
 CONTAINMENT SPRAY  
 66002  
 24-B-24-2  
 17X22

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1. B. V

MS Lin F



REFERENCE DRAWINGS

- M-2048 - 10' PIPING PLAN AREA
- M-2049 REF. AREA


RECHTEL	
SAN FRANCISCO	
ARMASIS POWER & LIGHT COMPANY	
ARMASIS NUCLEAR ONE	
SHEET 2	
ISOMETRIC - CONTAINMENT AUXILIARY	
CONTAINMENT SPRAY	
5600-2	2 HCB-15-1
17782	

ISI-278

- 1. PIPING ON 10'0" CONCRETE ON 10'0" SLAB
- 2. PIPING ON 10'0" CONCRETE ON 10'0" SLAB
- 3. PIPING ON 10'0" CONCRETE ON 10'0" SLAB

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19 LF

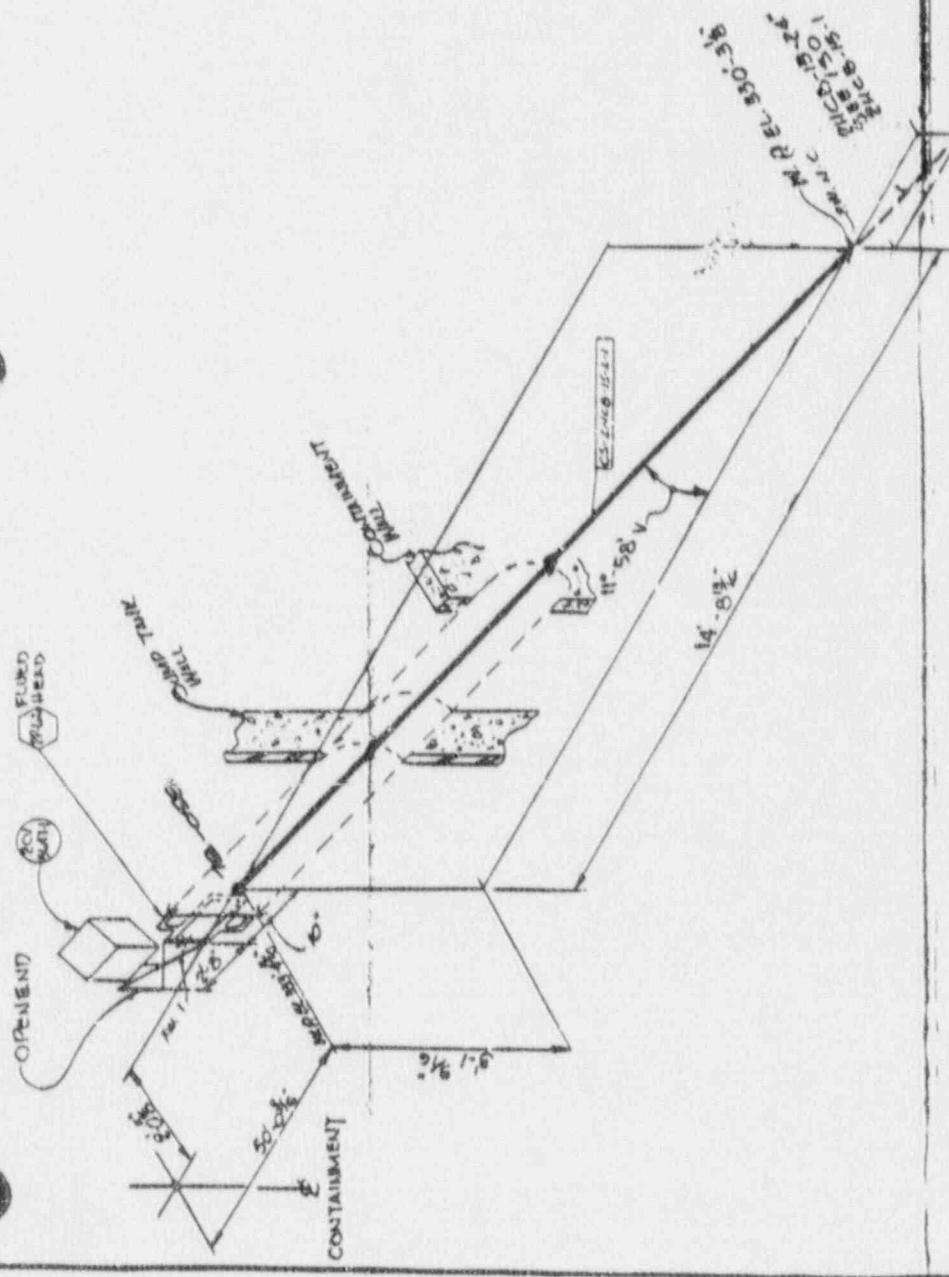

REFERENCE DRAWINGS  
 M-2236 Rev 24 P&ID  
 M-2046 Rev. 16 P&IDG Plus Area 24  
 M-2057 Rev. 17 - - - 25

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88	1/15/69	...	...	...
89	2/15/69	...	...	...
90	3/15/69	...	...	...
91	4/15/69	...	...	...
92	5/15/69	...	...	...
93	6/15/69	...	...	...
94	7/15/69	...	...	...
95	8/15/69	...	...	...
96	9/15/69	...	...	...
97	10/15/69	...	...	...
98	11/15/69	...	...	...
99	12/15/69	...	...	...
100	1/15/70	...	...	...

BECHTEL  
 SAN FRANCISCO, CA  
 ADDRESS POWER & LIGHT COMPANY  
 AREAAS NUCLEAR ONE  
 UNIT 1  
 ISOMETRIC-CONTAINMENT PLD. 1  
 CONTAINMENT SPRAY  
 66002 2109-15-2  
 17x22

ISI-278

1 PIPE SPONGE CS-246B-15-24  
 1 BCV-5687-1

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16 X

I certify that the image contained on this frame was made in the normal and regular course of business, on the date stated below and that it is an accurate reproduction of the document submitted to Micrographics.  
 DATE: 11-17-72






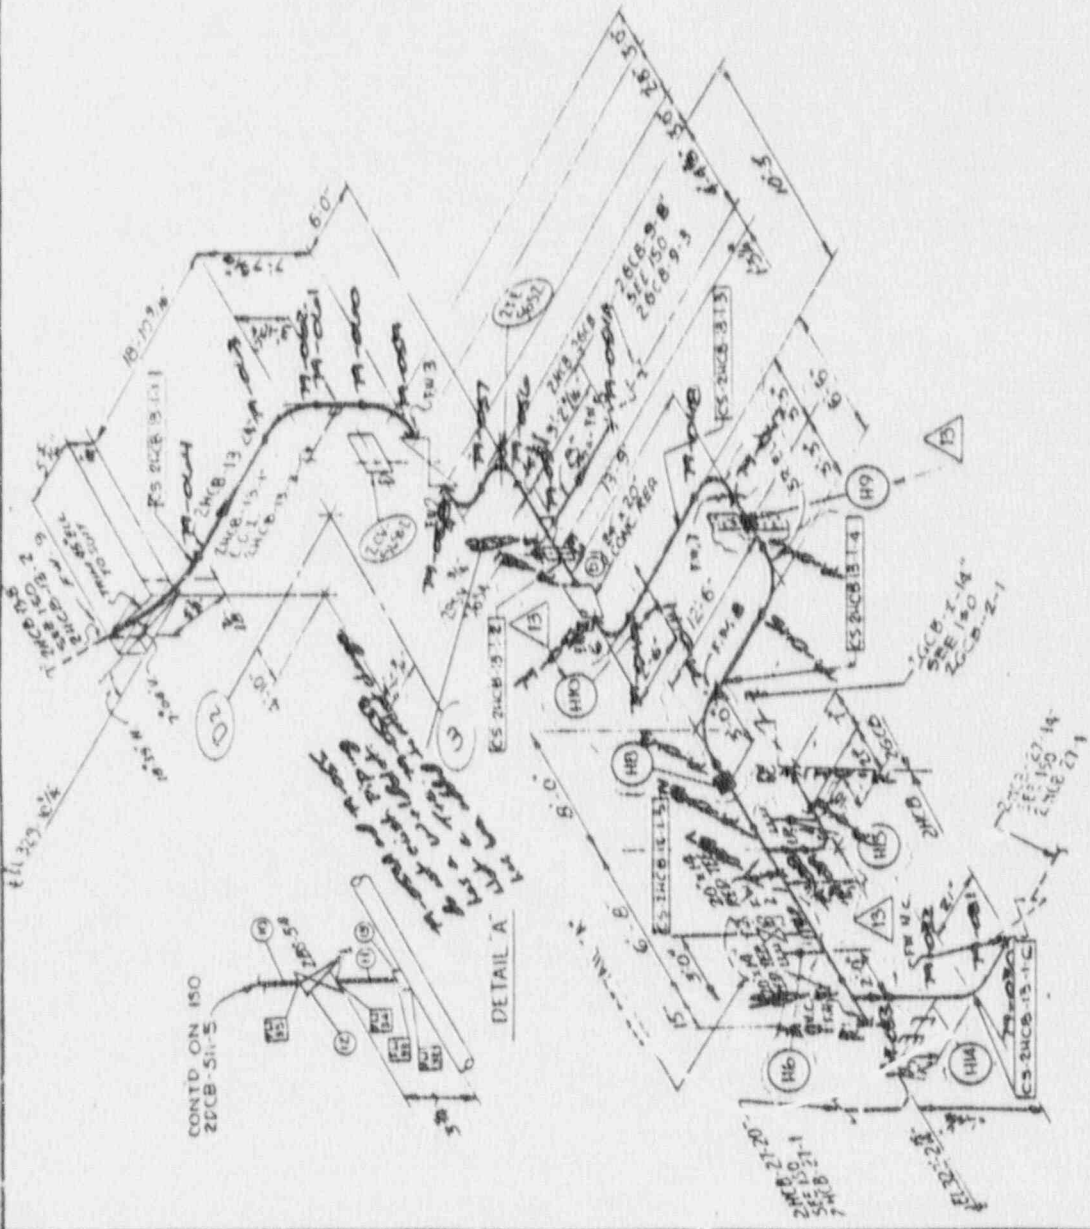




116 Lin Ft  
 61A

REFERENCE DRAWINGS  
 M-2232 REV 25 P 11D  
 M-2236 " 74  
 M-2042 " 88 PIPING PLAN AREA 24 & 26

		<b>66002</b>		<b>2 HCB-J3-1 B</b>	
<b>ISOMETRIC - CONTAINMENT AUX BUILDING          CONTAINMENT SPRAY</b>					
<b>ADDRESS POWER &amp; LIGHT COMPANY          ASSUMERS BUILDING ONE          PAGE 2</b>					
<b>SAN FRANCISCO</b>					
<b>ESORTEL</b>					
DATE: 11/15/74 DRAWN BY: [unclear] CHECKED BY: [unclear] APPROVED BY: [unclear]					



FW-5" 740 RELOCATED TO SUIT INST.


ITEM NO	DESCRIPTION	QTY	UNIT
1	PIPE SPOOL MARK CS-2HCB-13-1-1	1	ILP
2	PIPE SPOOL MARK CS-2HCB-13-1-2	1	ILP
3	PIPE SPOOL MARK CS-2HCB-13-1-3	1	ILP
4	PIPE SPOOL MARK CS-2HCB-13-1-4	1	ILP
5	PIPE SPOOL MARK CS-2HCB-13-1-5	1	ILP
6	PIPE SPOOL MARK CS-2HCB-13-1-6	1	ILP
7	PIPE SPOOL MARK CS-2HCB-13-1-7	1	ILP
8	PIPE SPOOL MARK CS-2HCB-13-1-8	1	ILP
9	PIPE SPOOL MARK CS-2HCB-13-1-9	1	ILP
10	PIPE SPOOL MARK CS-2HCB-13-1-10	1	ILP
11	2" PIPE SA-312 1P 304 SS 40' W/ 60# 404	11	ILP
12	2" CLAS CT MEDIUM WTD SERIAL P/ODE 1973	12	ILP
13	2" HALF DRG 30007 2 1/2 SA 1R F 304 H/CR	13	ILP

**BILL OF MATERIAL**

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REV 1 NOTE  
 ADDED SYMBOL FOR 1000  
 ADDED 1000 TO ALL 1000  
 INCLUDE FOR CONSTRUCTION

REV 2 NOTE  
 ADDED 1000 TO ALL 1000  
 INCLUDE FOR CONSTRUCTION

REV 3 NOTE  
 ADDED 1000 TO ALL 1000  
 INCLUDE FOR CONSTRUCTION

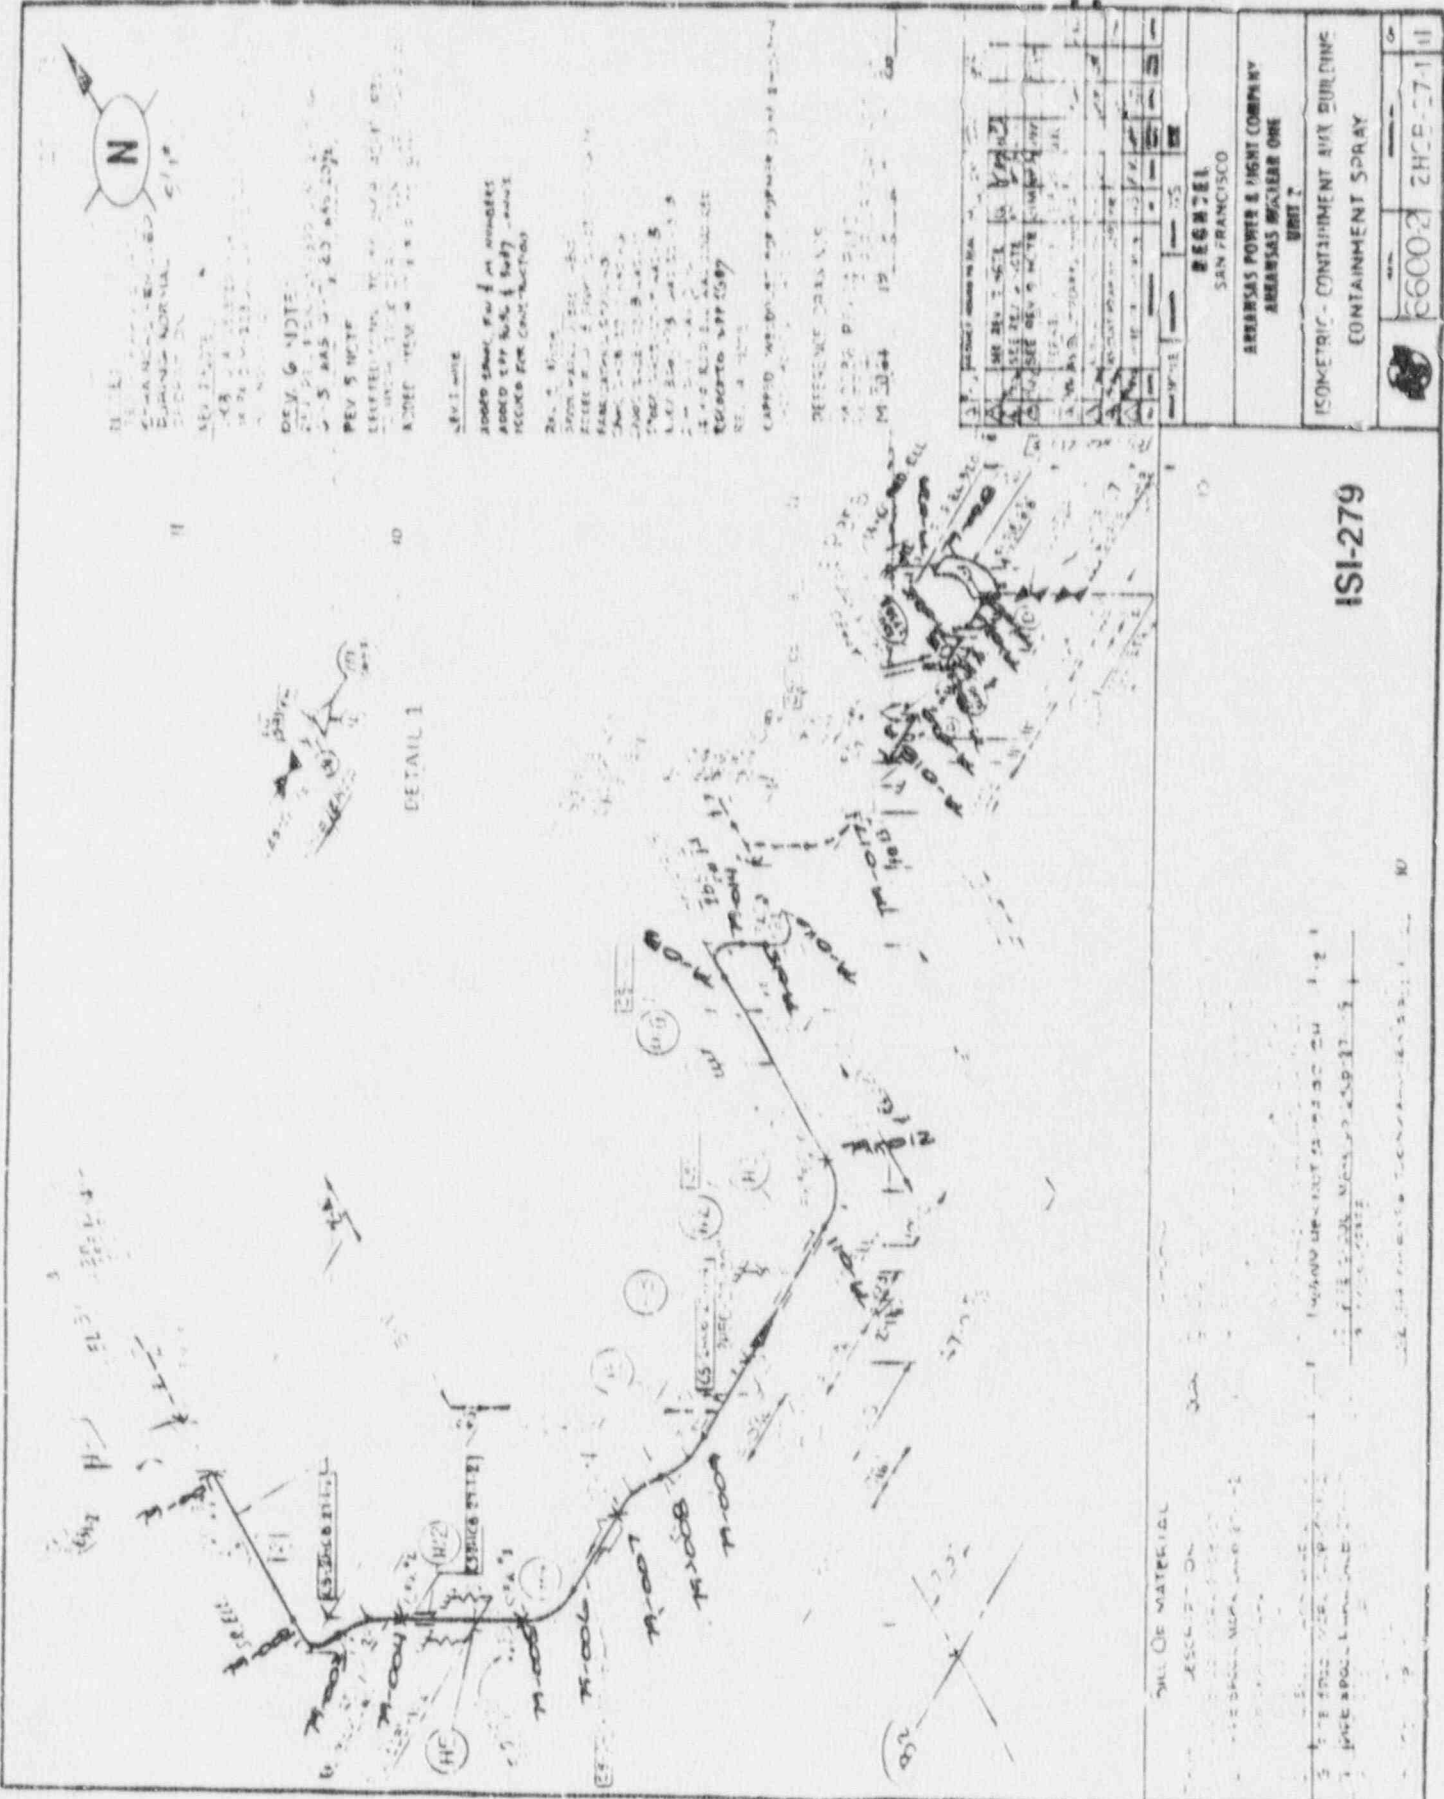REV 4 NOTE  
 ADDED 1000 TO ALL 1000  
 INCLUDE FOR CONSTRUCTION

REV 5 NOTE  
 ADDED 1000 TO ALL 1000  
 INCLUDE FOR CONSTRUCTION

REV 6 NOTE  
 ADDED 1000 TO ALL 1000  
 INCLUDE FOR CONSTRUCTION

REV 7 NOTE  
 ADDED 1000 TO ALL 1000  
 INCLUDE FOR CONSTRUCTION



REV 8 NOTE  
 ADDED 1000 TO ALL 1000  
 INCLUDE FOR CONSTRUCTION

ISI-279

REGENTEL SAN FRANCISCO	
ARRISSAS POWER & LIGHT COMPANY ARRISSAS BACKLASH ONE BUREAU	
ISOMETRIC - CONTAINMENT AIR BUILDING CONTAINMENT SPRAY	
66002	2HCE-71 II





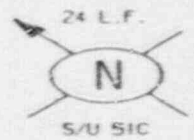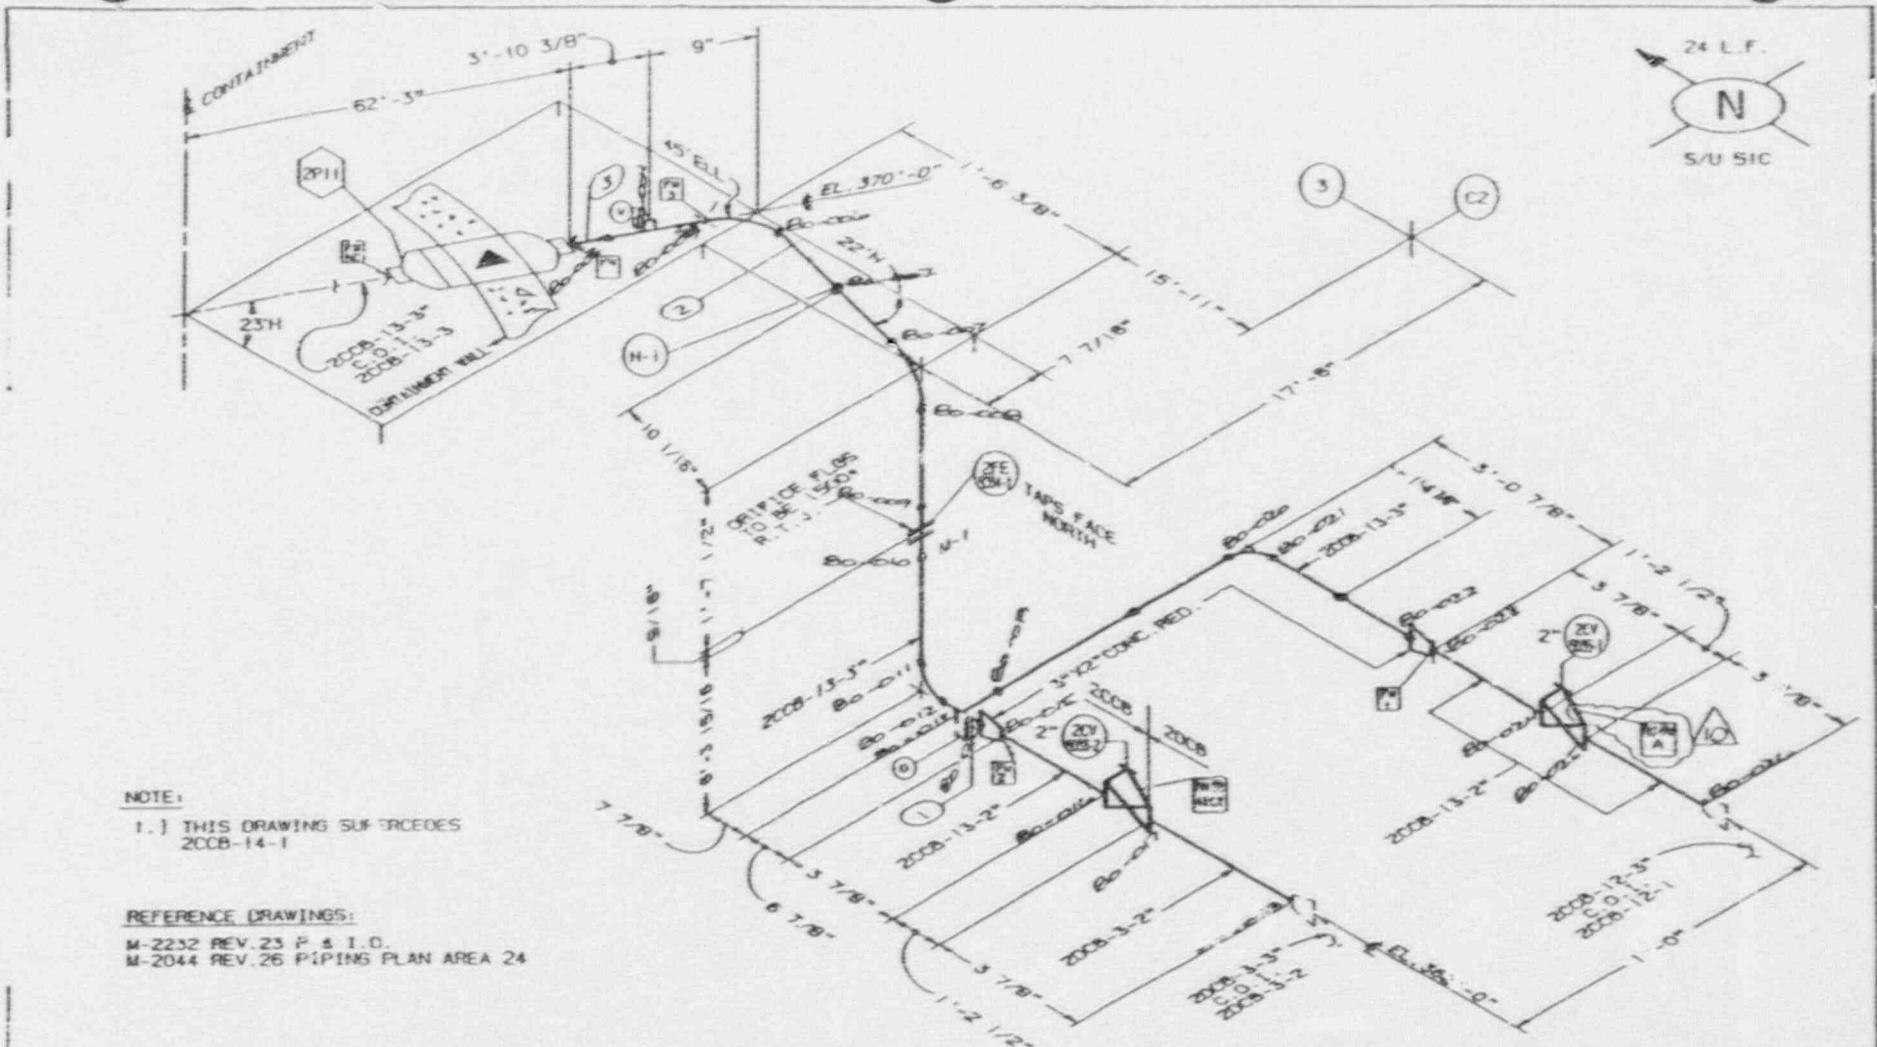

**NOTE:**

1.) THIS DRAWING SUPERSEDES  
2CCB-14-1

**REFERENCE DRAWINGS:**


M-2232 REV. 23 P & I.D.  
M-2044 REV. 26 PIPING PLAN AREA 24

DESCRIPTION	HEAT NO.	ASTM	GRD
2CY-3036-2			
2CY-3032-1			
2CY-3034-1			
PIPE SPOOL MARK: 81-2CCB-13-2-3			
PIPE SPOOL MARK: 31-2CCB-13-2-2			
PIPE SPOOL MARK: 51-2CCB-13-2-1			

BILL OF MATERIAL

STARTUP NO. INSULATION CLASS THICK

REFERENCE	NO.	DATE	REVISION	BY	CHKD.
P. BLDG. NO. M-2232	10	1/2/90	AS BUILT - WRT. DB. CHZ 4	KB	WRT
PIPING DWG. M-2044	9	11/28/85	AS BUILT - PEAR. BG. 2890 TMA. EWD		
AREA NO. 24	8		REVISION FOR PIPING QUALITY	GPC	JA
ELEV.					
BLDG. REACTOR ALX.					
SYS. SAFETY INJECTION SYSTEM					
HANGER TYPE					
DWG. NO.					
SYS. CLEARING REQMT.					
SERVICE CONDITIONS					
NORMAL _____ PSI					
MAXIMUM _____ PSI					
<b>ARKANSAS POWER AND LIGHT COMPANY</b> <b>ARKANSAS NUCLEAR ONE</b> <b>UNIT 2</b>		<b>LARGE PIPE ISOMETRIC</b> <b>SAFETY INJECTION SYSTEM</b>			
		DRAWING NO. <b>2CCB-13-2</b>	REV. <b>10</b>		

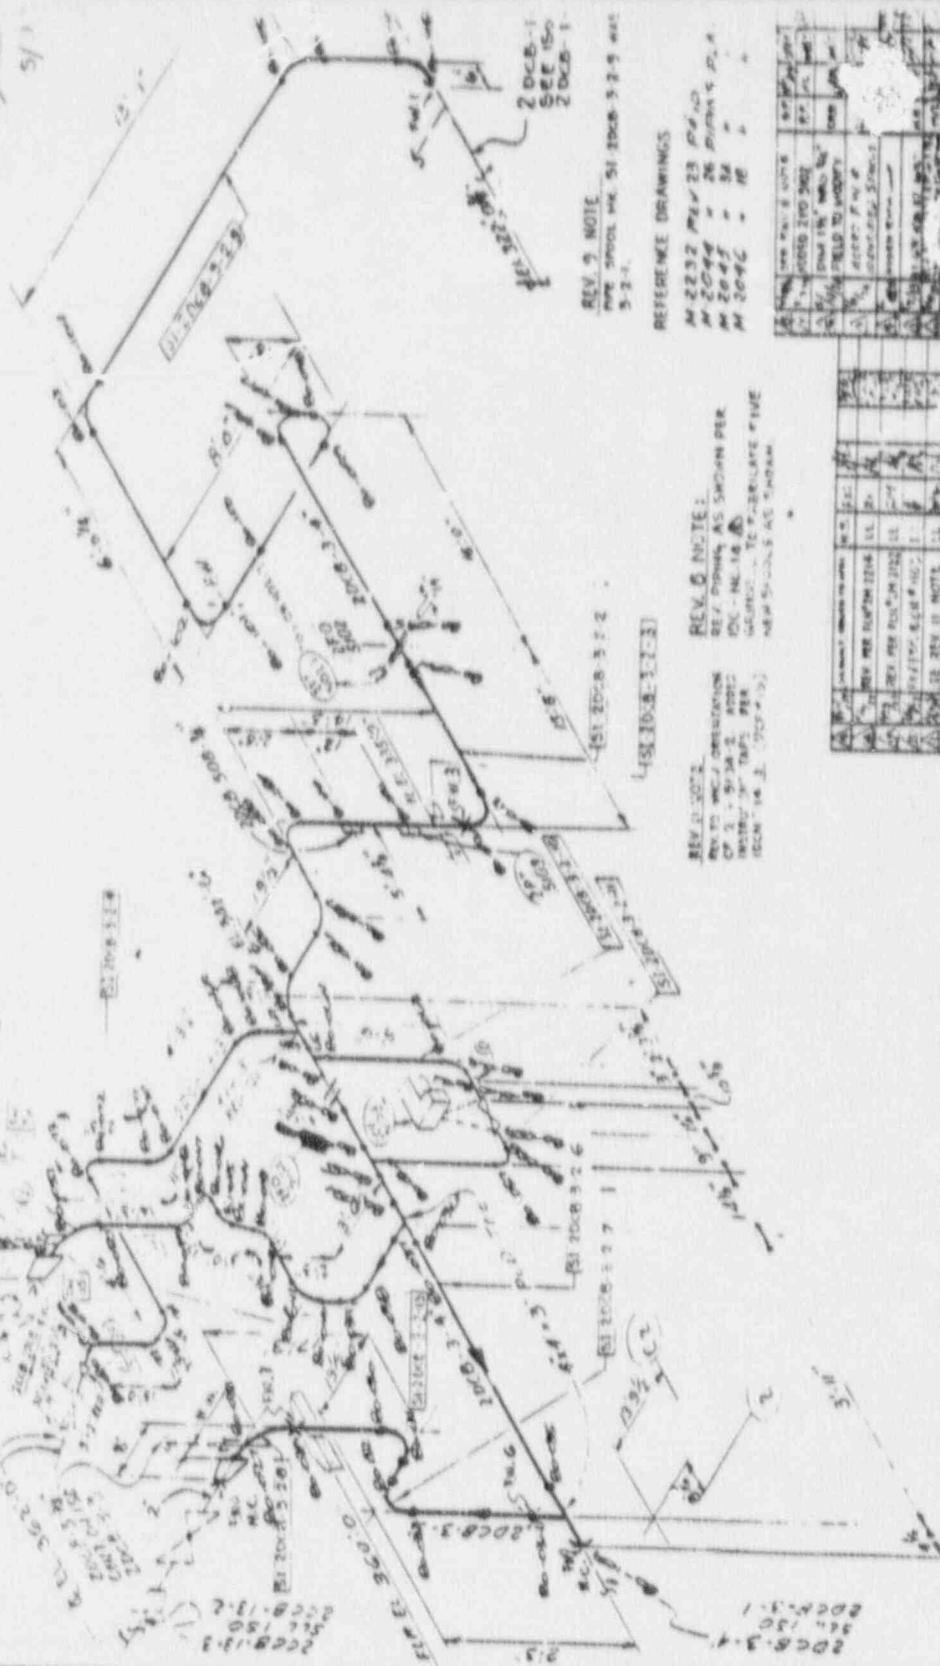

REV. 9 NOTE  
 PIPE SPOOL PER SI 20CB-3-2-9 AND  
 3-2-1

REFERENCE DRAWINGS  
 M 2032 PER 23 P.D.  
 M 2044 = 26 DIMS & P.L.A.  
 M 2047 = 31  
 M 2048 = 18

REV. 5 NOTE  
 REV. 5 PER 10CB-3-2-2

REV. 6 NOTE  
 REV. 6 PER 10CB-3-2-3

REV. 7 NOTE  
 REV. 7 PER 10CB-3-2-4

REV. 8 NOTE  
 REV. 8 PER 10CB-3-2-5

REV. 9 NOTE  
 REV. 9 PER 10CB-3-2-6

REV. 10 NOTE  
 REV. 10 PER 10CB-3-2-7

REV. 11 NOTE  
 REV. 11 PER 10CB-3-2-8

REV. 12 NOTE  
 REV. 12 PER 10CB-3-2-9

REV. 13 NOTE  
 REV. 13 PER 10CB-3-2-10

REV. 14 NOTE  
 REV. 14 PER 10CB-3-2-11

REV. 15 NOTE  
 REV. 15 PER 10CB-3-2-12

REV. 16 NOTE  
 REV. 16 PER 10CB-3-2-13

REV. 17 NOTE  
 REV. 17 PER 10CB-3-2-14

REV. 18 NOTE  
 REV. 18 PER 10CB-3-2-15

REV. 19 NOTE  
 REV. 19 PER 10CB-3-2-16

REV. 20 NOTE  
 REV. 20 PER 10CB-3-2-17

REV. 21 NOTE  
 REV. 21 PER 10CB-3-2-18

REV. 22 NOTE  
 REV. 22 PER 10CB-3-2-19

REV. 23 NOTE  
 REV. 23 PER 10CB-3-2-20

REV. 24 NOTE  
 REV. 24 PER 10CB-3-2-21

REV. 25 NOTE  
 REV. 25 PER 10CB-3-2-22

REV. 26 NOTE  
 REV. 26 PER 10CB-3-2-23

REV. 27 NOTE  
 REV. 27 PER 10CB-3-2-24

REV. 28 NOTE  
 REV. 28 PER 10CB-3-2-25

REV. 29 NOTE  
 REV. 29 PER 10CB-3-2-26

REV. 30 NOTE  
 REV. 30 PER 10CB-3-2-27

REV. 31 NOTE  
 REV. 31 PER 10CB-3-2-28

REV. 32 NOTE  
 REV. 32 PER 10CB-3-2-29

REV. 33 NOTE  
 REV. 33 PER 10CB-3-2-30

REV. 34 NOTE  
 REV. 34 PER 10CB-3-2-31

REV. 35 NOTE  
 REV. 35 PER 10CB-3-2-32

REV. 36 NOTE  
 REV. 36 PER 10CB-3-2-33

REV. 37 NOTE  
 REV. 37 PER 10CB-3-2-34

REV. 38 NOTE  
 REV. 38 PER 10CB-3-2-35

REV. 39 NOTE  
 REV. 39 PER 10CB-3-2-36

REV. 40 NOTE  
 REV. 40 PER 10CB-3-2-37

REV. 41 NOTE  
 REV. 41 PER 10CB-3-2-38

REV. 42 NOTE  
 REV. 42 PER 10CB-3-2-39

REV. 43 NOTE  
 REV. 43 PER 10CB-3-2-40

REV. 44 NOTE  
 REV. 44 PER 10CB-3-2-41

REV. 45 NOTE  
 REV. 45 PER 10CB-3-2-42

REV. 46 NOTE  
 REV. 46 PER 10CB-3-2-43

REV. 47 NOTE  
 REV. 47 PER 10CB-3-2-44

REV. 48 NOTE  
 REV. 48 PER 10CB-3-2-45

REV. 49 NOTE  
 REV. 49 PER 10CB-3-2-46

REV. 50 NOTE  
 REV. 50 PER 10CB-3-2-47

REV. 51 NOTE  
 REV. 51 PER 10CB-3-2-48

REV. 52 NOTE  
 REV. 52 PER 10CB-3-2-49

REV. 53 NOTE  
 REV. 53 PER 10CB-3-2-50

REV. 54 NOTE  
 REV. 54 PER 10CB-3-2-51

REV. 55 NOTE  
 REV. 55 PER 10CB-3-2-52

REV. 56 NOTE  
 REV. 56 PER 10CB-3-2-53

REV. 57 NOTE  
 REV. 57 PER 10CB-3-2-54

REV. 58 NOTE  
 REV. 58 PER 10CB-3-2-55

REV. 59 NOTE  
 REV. 59 PER 10CB-3-2-56

REV. 60 NOTE  
 REV. 60 PER 10CB-3-2-57

REV. 61 NOTE  
 REV. 61 PER 10CB-3-2-58

REV. 62 NOTE  
 REV. 62 PER 10CB-3-2-59

REV. 63 NOTE  
 REV. 63 PER 10CB-3-2-60

REV. 64 NOTE  
 REV. 64 PER 10CB-3-2-61

REV. 65 NOTE  
 REV. 65 PER 10CB-3-2-62

REV. 66 NOTE  
 REV. 66 PER 10CB-3-2-63

REV. 67 NOTE  
 REV. 67 PER 10CB-3-2-64

REV. 68 NOTE  
 REV. 68 PER 10CB-3-2-65

REV. 69 NOTE  
 REV. 69 PER 10CB-3-2-66

REV. 70 NOTE  
 REV. 70 PER 10CB-3-2-67

REV. 71 NOTE  
 REV. 71 PER 10CB-3-2-68

REV. 72 NOTE  
 REV. 72 PER 10CB-3-2-69

REV. 73 NOTE  
 REV. 73 PER 10CB-3-2-70

REV. 74 NOTE  
 REV. 74 PER 10CB-3-2-71

REV. 75 NOTE  
 REV. 75 PER 10CB-3-2-72

REV. 76 NOTE  
 REV. 76 PER 10CB-3-2-73

REV. 77 NOTE  
 REV. 77 PER 10CB-3-2-74

REV. 78 NOTE  
 REV. 78 PER 10CB-3-2-75

REV. 79 NOTE  
 REV. 79 PER 10CB-3-2-76

REV. 80 NOTE  
 REV. 80 PER 10CB-3-2-77

REV. 81 NOTE  
 REV. 81 PER 10CB-3-2-78

REV. 82 NOTE  
 REV. 82 PER 10CB-3-2-79

REV. 83 NOTE  
 REV. 83 PER 10CB-3-2-80

REV. 84 NOTE  
 REV. 84 PER 10CB-3-2-81

REV. 85 NOTE  
 REV. 85 PER 10CB-3-2-82

REV. 86 NOTE  
 REV. 86 PER 10CB-3-2-83

REV. 87 NOTE  
 REV. 87 PER 10CB-3-2-84

REV. 88 NOTE  
 REV. 88 PER 10CB-3-2-85

REV. 89 NOTE  
 REV. 89 PER 10CB-3-2-86

REV. 90 NOTE  
 REV. 90 PER 10CB-3-2-87

REV. 91 NOTE  
 REV. 91 PER 10CB-3-2-88

REV. 92 NOTE  
 REV. 92 PER 10CB-3-2-89

REV. 93 NOTE  
 REV. 93 PER 10CB-3-2-90

REV. 94 NOTE  
 REV. 94 PER 10CB-3-2-91

REV. 95 NOTE  
 REV. 95 PER 10CB-3-2-92

REV. 96 NOTE  
 REV. 96 PER 10CB-3-2-93

REV. 97 NOTE  
 REV. 97 PER 10CB-3-2-94

REV. 98 NOTE  
 REV. 98 PER 10CB-3-2-95

REV. 99 NOTE  
 REV. 99 PER 10CB-3-2-96

REV. 100 NOTE  
 REV. 100 PER 10CB-3-2-97

REV. 101 NOTE  
 REV. 101 PER 10CB-3-2-98

REV. 102 NOTE  
 REV. 102 PER 10CB-3-2-99

REV. 103 NOTE  
 REV. 103 PER 10CB-3-2-100

Bill of Material

ITEM	DESCRIPTION	QUANTITY	UNIT	REFERENCE
1	PIPE SPOOL MARK SI 20CB-3-2-10	1	FT	
2	PIPE SPOOL MARK SI 20CB-3-2-11	1	FT	
3	PIPE SPOOL MARK SI 20CB-3-2-12	1	FT	
91	PIPE SPOOL MARK SI 20CB-3-2-100	1	FT	

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ISI-280

ve 80

Handwritten signature or initials

66002 20CB-3

BECHTEL  
SAN FRANCISCO  
AIRBORNE POWER & LIGHT CORP  
AMERICAN INDIAN OIL  
UNIT 2  
/SOME TRAC-CONTAINMENT AUX.  
SAFETY INJECTION





9/1/6



56-512

FEED IN LINE  
 SEE PLAN FOR FEED IN LINE  
 SEE PLAN FOR FEED IN LINE

REV NOTE  
 RELOCATED PLUMB TO CLEAR ACCESS FOR CONDUITING AT 20'-0" DIA

REV 10 NOTE  
 ADDED FLANGE FOR REMOVAL OF SPOOL 200B-1-15 TO CLEAR ACCESS FOR DEMONSTRATING OF 20" DIA.

REV 9 NOTE  
 RELOCATED 20" DIA AS INDICATED AS ABOVE INSTRUMENT TAPS PER 100% W-14 (DCB-1-15)

REV 8 NOTE  
 (X) WAS 200B-19-N (X) WAS 200B-23-C

REV 7 NOTE  
 200B-23 WAS 200B-19-N

REV 6 NOTE  
 200B-23 WAS 200B-19-N


REFERENCE DRAWINGS  
 M-2232 REV 118 P-110  
 M-2042 - 10 PIPING PLAN AREA 1/21/76

PREPARED BY: M.P. & SPOON, 1015 1/2 PLYMOUTH  
 VALUE ENGINEERING, 1015 1/2 PLYMOUTH  
 SAN FRANCISCO, CALIF. 94109

NO.	DATE	DESCRIPTION	BY	CHKD	APP'D
1	9/1/6	ISSUED FOR CONSTRUCTION	M.P.	S.P.	
2	9/1/6	ISSUED FOR CONSTRUCTION	M.P.	S.P.	
3	9/1/6	ISSUED FOR CONSTRUCTION	M.P.	S.P.	
4	9/1/6	ISSUED FOR CONSTRUCTION	M.P.	S.P.	
5	9/1/6	ISSUED FOR CONSTRUCTION	M.P.	S.P.	
6	9/1/6	ISSUED FOR CONSTRUCTION	M.P.	S.P.	
7	9/1/6	ISSUED FOR CONSTRUCTION	M.P.	S.P.	
8	9/1/6	ISSUED FOR CONSTRUCTION	M.P.	S.P.	
9	9/1/6	ISSUED FOR CONSTRUCTION	M.P.	S.P.	
10	9/1/6	ISSUED FOR CONSTRUCTION	M.P.	S.P.	
11	9/1/6	ISSUED FOR CONSTRUCTION	M.P.	S.P.	
12	9/1/6	ISSUED FOR CONSTRUCTION	M.P.	S.P.	
13	9/1/6	ISSUED FOR CONSTRUCTION	M.P.	S.P.	
14	9/1/6	ISSUED FOR CONSTRUCTION	M.P.	S.P.	
15	9/1/6	ISSUED FOR CONSTRUCTION	M.P.	S.P.	
16	9/1/6	ISSUED FOR CONSTRUCTION	M.P.	S.P.	
17	9/1/6	ISSUED FOR CONSTRUCTION	M.P.	S.P.	
18	9/1/6	ISSUED FOR CONSTRUCTION	M.P.	S.P.	
19	9/1/6	ISSUED FOR CONSTRUCTION	M.P.	S.P.	
20	9/1/6	ISSUED FOR CONSTRUCTION	M.P.	S.P.	
21	9/1/6	ISSUED FOR CONSTRUCTION	M.P.	S.P.	
22	9/1/6	ISSUED FOR CONSTRUCTION	M.P.	S.P.	
23	9/1/6	ISSUED FOR CONSTRUCTION	M.P.	S.P.	
24	9/1/6	ISSUED FOR CONSTRUCTION	M.P.	S.P.	
25	9/1/6	ISSUED FOR CONSTRUCTION	M.P.	S.P.	
26	9/1/6	ISSUED FOR CONSTRUCTION	M.P.	S.P.	
27	9/1/6	ISSUED FOR CONSTRUCTION	M.P.	S.P.	

BECHTEL  
 SAN FRANCISCO  
 AIRBORNE POWER & LIGHT COMPANY  
 AIRBORNE NUCLEAR ONE  
 SHEET 3  
 ISOMETRIC CONTAINMENT AUX. BLDG.  
 SAFETY INJECTION

56002	2018-1-1	15
-------	----------	----

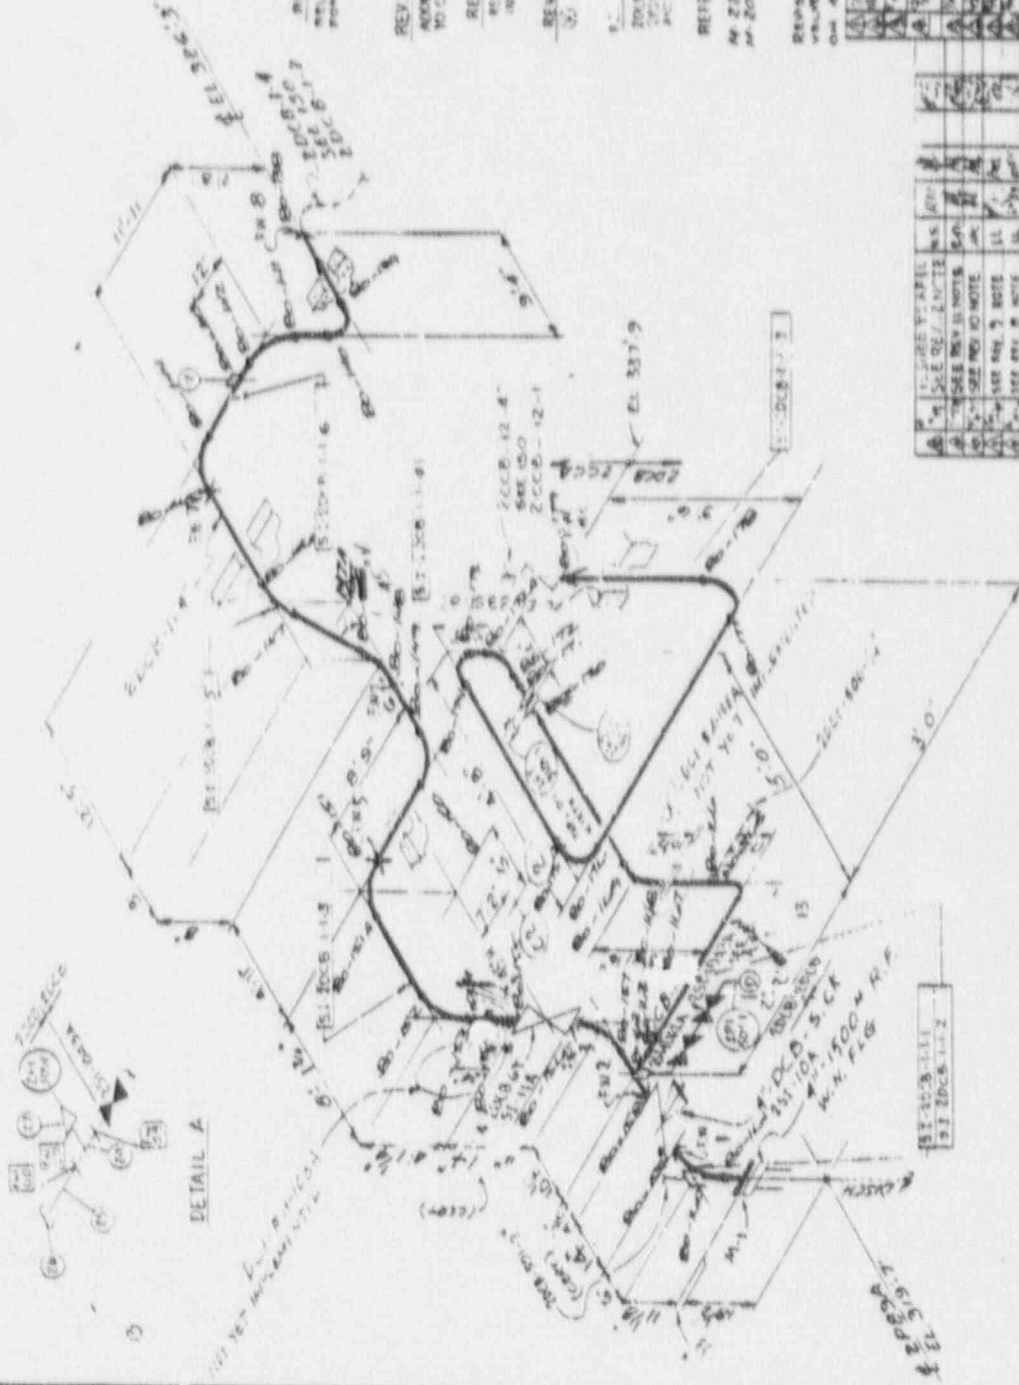

ITEM NO.	DESCRIPTION	QTY	UNIT	REMARKS
1	PIPE SPOOL MARK 'S1' 20'-0" 1-1	1	PC	
2	PIPE SPOOL MARK 'S1' 20'-0" 1-2	1	PC	
3	PIPE SPOOL MARK 'S1' 20'-0" 1-3	1	PC	
4	PIPE SPOOL MARK 'S1' 20'-0" 1-4	1	PC	
5	PIPE SPOOL MARK 'S1' 20'-0" 1-5	1	PC	
6	PIPE SPOOL MARK 'S1' 20'-0" 1-6	1	PC	
7	FLEXIBULAR GASKET STYLE CG-RL	1	EA	

ISI-280

Zone 80  
 2018-1-1

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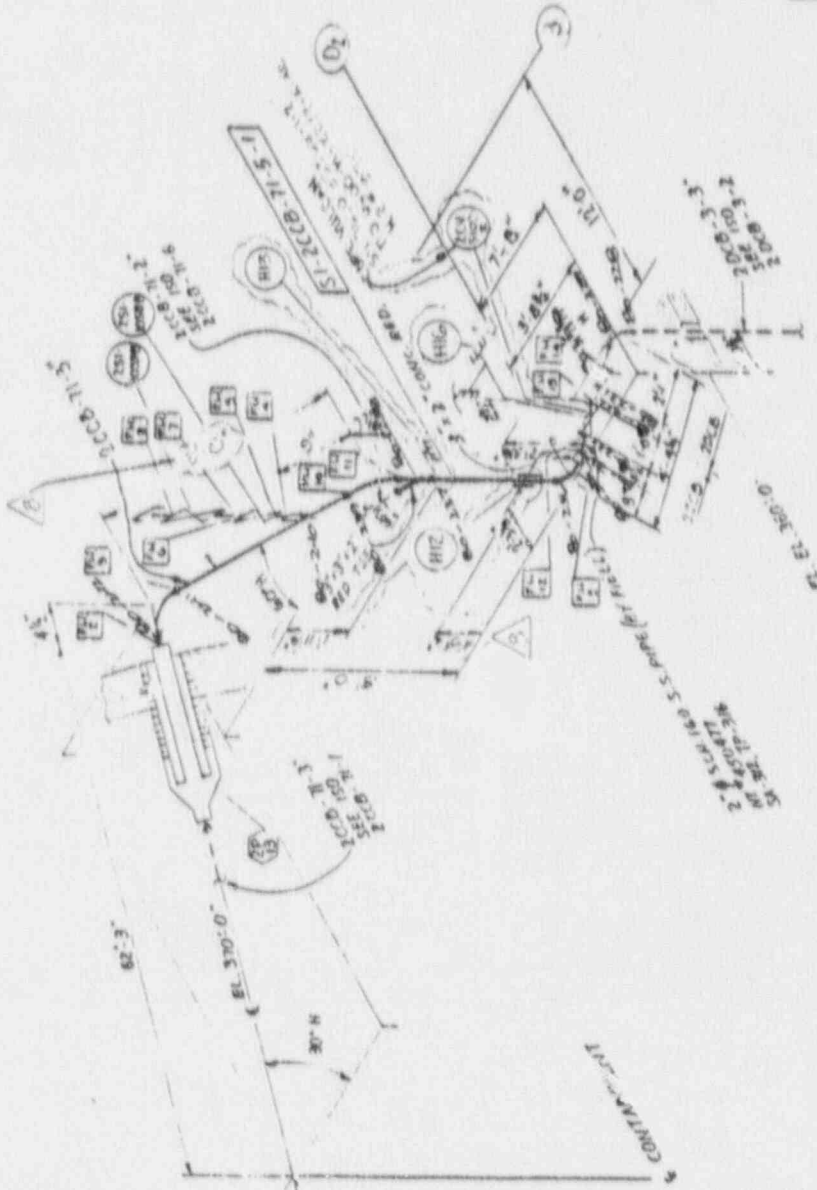


20 LF



5/05

REFERENCE DRAWINGS  
M-2232 REV. 29 P&ID (REV. 44)  
M-2044 REV. 24 PIPING PLAN AREA 24



NO.	DESCRIPTION	DATE	BY	CHKD.
1	ISSUED FOR CONSTRUCTION	05/05/05	J. L. [unclear]	[unclear]
2	REVISED FOR [unclear]	05/05/05	J. L. [unclear]	[unclear]
3	REVISED FOR [unclear]	05/05/05	J. L. [unclear]	[unclear]
4	REVISED FOR [unclear]	05/05/05	J. L. [unclear]	[unclear]
5	REVISED FOR [unclear]	05/05/05	J. L. [unclear]	[unclear]
6	REVISED FOR [unclear]	05/05/05	J. L. [unclear]	[unclear]
7	REVISED FOR [unclear]	05/05/05	J. L. [unclear]	[unclear]
8	REVISED FOR [unclear]	05/05/05	J. L. [unclear]	[unclear]
9	REVISED FOR [unclear]	05/05/05	J. L. [unclear]	[unclear]
10	REVISED FOR [unclear]	05/05/05	J. L. [unclear]	[unclear]

REVISION  
SAN FRANCISCO

ARMSTRONG POWER & LIGHT COMPANY  
ARMSTRONG NUCLEAR ONE  
SHEET 2

ISOMETRIC - CONTAINMENT AUX. DLDg  
SAFETY INJECTION

66002 ZCCB-71-5 8

NOTES:  
1. 4" PIPE, VALVES & FITTINGS CONFORM TO MAT'L SPECS ON PILE.

ISI-280

OF MATERIAL

DESCRIPTION	QUAN.
MARK, SI-2CCB-71-5-1	1
2-2 VALVE	1
2-2	1
MARK, SI-2CCB-71-5-1	2
MARK, SI-2CCB-71-5-1	1
MARK, SI-2CCB-71-5-1	2
MARK, SI-2CCB-71-5-1	1

A

A

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C

Zone 80  
8-200










**REV. 1 NOTE:**

REVISED FOR CONSTRUCTION  
 DATE: APR 2008-71-2

**REVISIONS DRAWINGS**

M 150 JUN 07 P410 (CDC #19)  
 M 2022 APR 05 P410 (CDC #19)  
 M 2025 APR 05 P410 (CDC #19)  
 M 2027 APR 05 P410 (CDC #19)

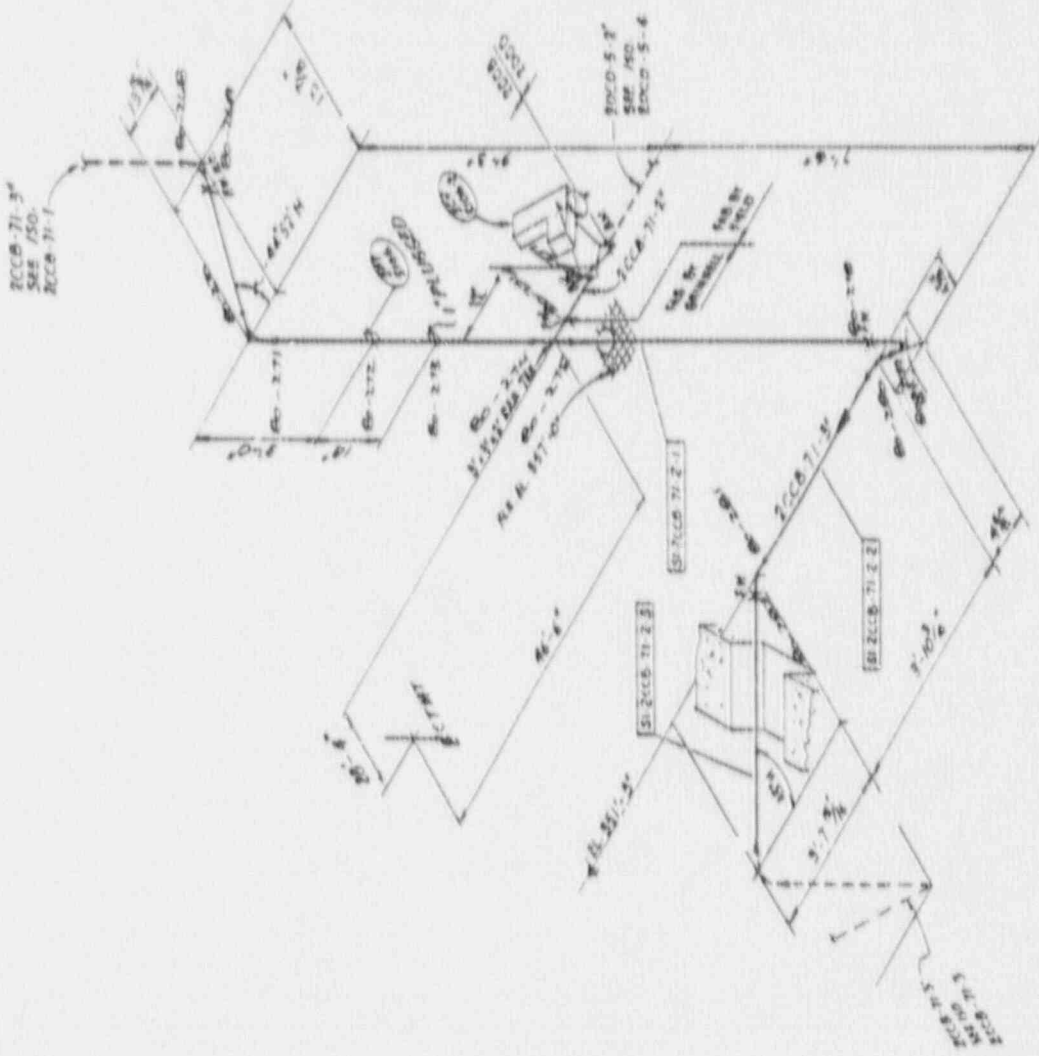

NO.	DESCRIPTION	DATE	BY	CHECKED
1	ISSUED FOR CONSTRUCTION	04/05/08	J. J. [unclear]	[unclear]
2	REVISED FOR CONSTRUCTION	04/05/08	J. J. [unclear]	[unclear]
3	REVISED FOR CONSTRUCTION	04/05/08	J. J. [unclear]	[unclear]
4	REVISED FOR CONSTRUCTION	04/05/08	J. J. [unclear]	[unclear]
5	REVISED FOR CONSTRUCTION	04/05/08	J. J. [unclear]	[unclear]
6	REVISED FOR CONSTRUCTION	04/05/08	J. J. [unclear]	[unclear]
7	REVISED FOR CONSTRUCTION	04/05/08	J. J. [unclear]	[unclear]
8	REVISED FOR CONSTRUCTION	04/05/08	J. J. [unclear]	[unclear]
9	REVISED FOR CONSTRUCTION	04/05/08	J. J. [unclear]	[unclear]
10	REVISED FOR CONSTRUCTION	04/05/08	J. J. [unclear]	[unclear]

**BECHTEL**  
 SAN FRANCISCO

AMERICAN POWER & LIGHT COMPANY  
 AMERICAN NUCLEAR CORP.  
 UNIT 2

ISOMETRIC CONTAINMENT BLDGS  
 SAFETY INJECTION SYSTEM

660020008-71-215


ISI-280

**FILE COMMENTS**

1	FILE CHANGE MADE TO RCCB 71-2-1	1
2		2-2
3		2-3
4		2-4
5	2008-5106-2 MAKE	1

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Page 80

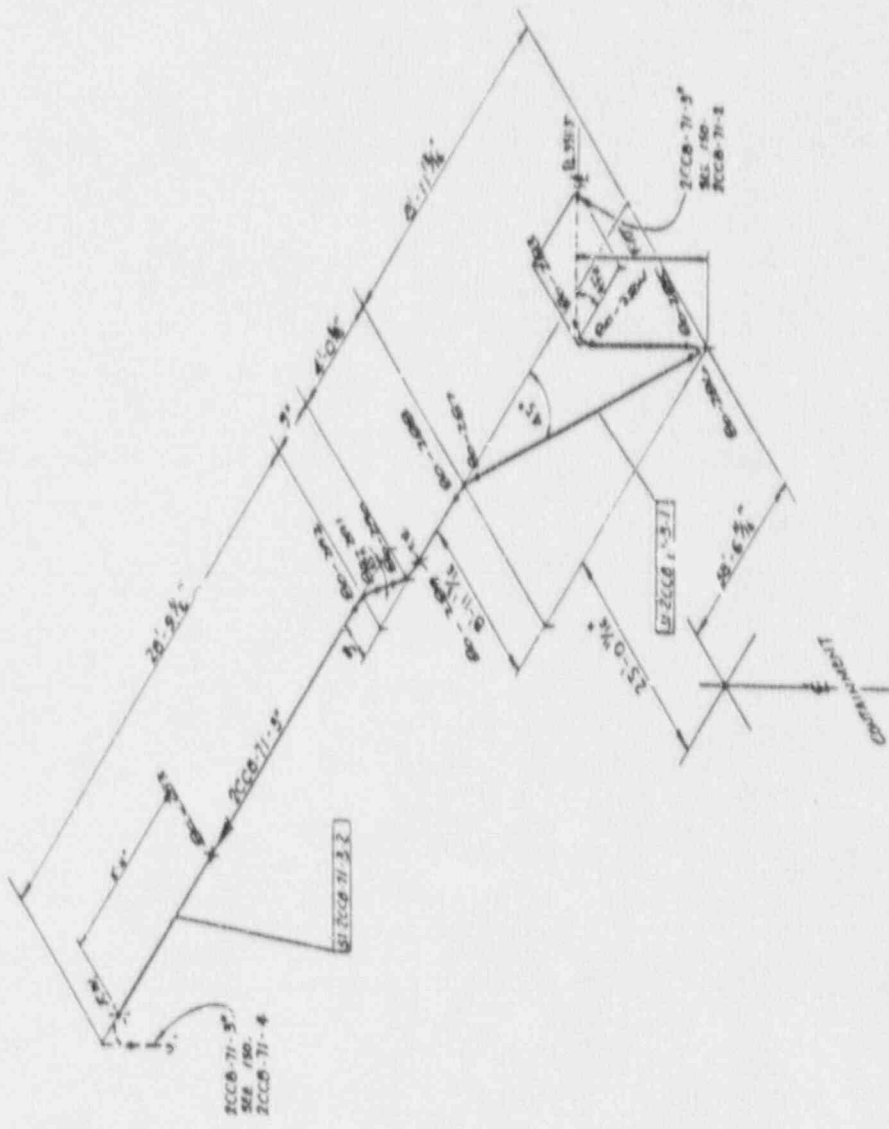

REFERENCE DRAWINGS  
 M-2250 REV 11 P 8 10 (LOC #18)  
 M-2252 REV 15 P 8 10 (LOC #18)  
 M-2057 REV. PIPING PLAN - AREA 21

RECEIVED	
SAN FRANCISCO	
AMERICAN POWER & LIGHT COMPANY	
AMERICAN BRIDGE ONE	
SHEET 2	
ISOMETRIC CONTAINMENT BLOB	
SAFETY INJECTION SYSTEM	
660022CCB-71-3-4	



ISI-280

FILE NO	660022CCB-71-3-4
DATE	11-1-66
BY	J. E. ...
CHECKED BY	...
APPROVED BY	...

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Zone 80



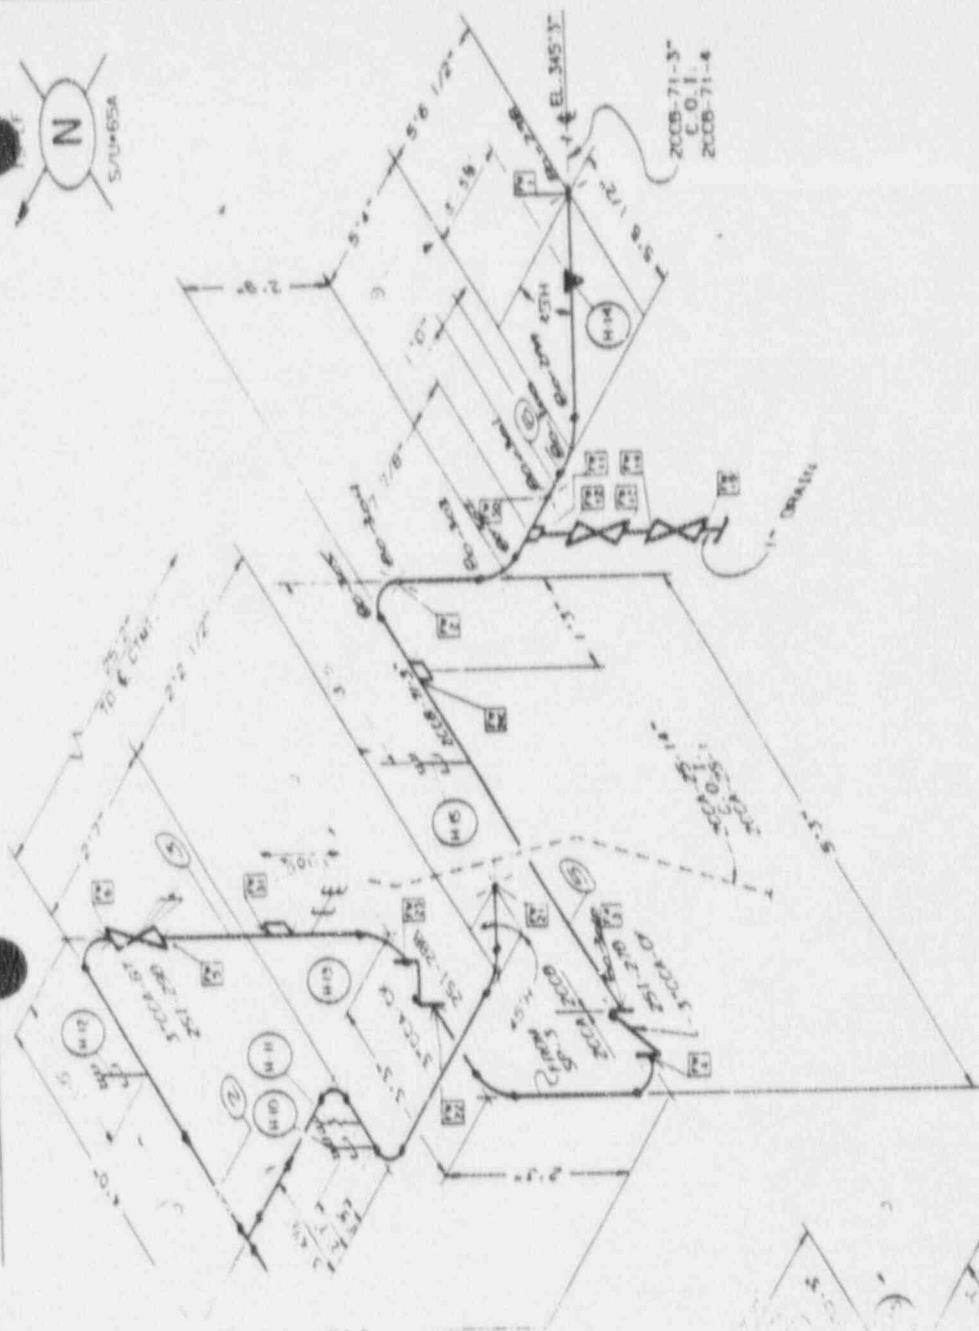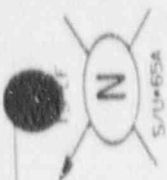

20CB-71-3  
C.O.I.  
20CB-71-4

NO.	DATE	REVISION	BY	CHKD.
1	11-11-70	J.A.	J.C.	
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REFERENCE  
 P&ID NO. M-2250  
 P&ID DWG. M-2057  
 AREA NO. 20  
 ELEV.  
 BLDG. REACTOR BUILDINGS  
 SYS. SAFETY INJECTION SYSTEM

HANDER TYPE  
 Dwg. No.  
 Sys. Cleaning Note

SERVICE CONDITIONS  
 NORMAL  
 PISC  
 PISC

ARIZONA POWER AND LIGHT COMPANY  
 ARIZONA NUCLEAR ONE  
 UNIT 1

LARGE PIPE ISOMETRIC  
 SAFETY INJECTION SYSTEM

20CA-255-3 9


REV. NO.	DATE	BY	CHKD.
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ISI-28C

Zone 80  
 80-298-80-306



75 L.F.

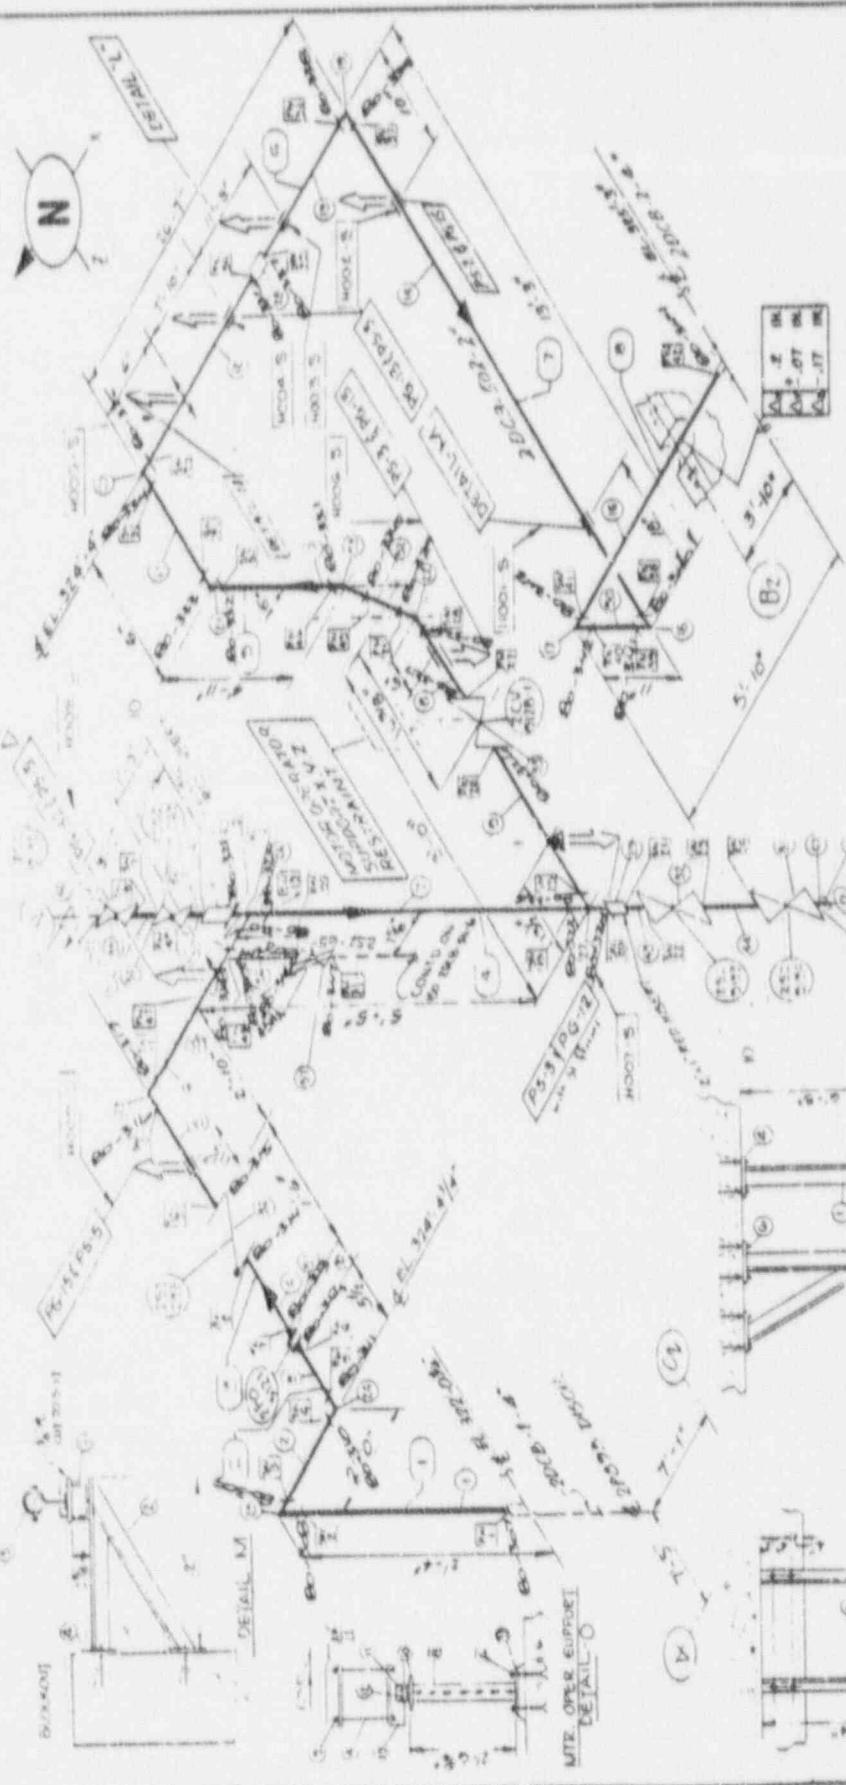

DETAIL M




DETAIL N



DETAIL O




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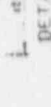
DETAIL Q

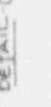


DETAIL R




DETAIL S

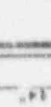


DETAIL T

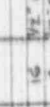

DETAIL U

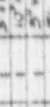

DETAIL V

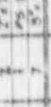

DETAIL W

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REVISIONS	NO.	DATE	DESCRIPTION
1	1	10/1/58	ISSUED FOR CONSTRUCTION
2	2	10/1/58	ISSUED FOR CONSTRUCTION
3	3	10/1/58	ISSUED FOR CONSTRUCTION
4	4	10/1/58	ISSUED FOR CONSTRUCTION
5	5	10/1/58	ISSUED FOR CONSTRUCTION
6	6	10/1/58	ISSUED FOR CONSTRUCTION
7	7	10/1/58	ISSUED FOR CONSTRUCTION
8	8	10/1/58	ISSUED FOR CONSTRUCTION
9	9	10/1/58	ISSUED FOR CONSTRUCTION
10	10	10/1/58	ISSUED FOR CONSTRUCTION

SECRET  
 SAN FRANCISCO  
 ARKANSAS POWER & LIGHT  
 ARKANSAS NUCLEAR ONE  
 UNIT 2  
**SMALL PIPE ISOMETRIC  
 AUXILIARY BUILDING**  
 6600-2/DCB-5021 Rev. 110

REFERENCE  
 P&ID NO. M-1132  
 Piping Code: P-1-2946  
 AREA NO. 24  
 REVISION: 317-D  
 NUCLEAR  
 MEDICAL INSTRUMENT NUT  
 EYE SAFETY - INSULATION

OWNER TYPE: SECUR CLASS 1  
 (N) CIVIL

STEEL CLEARING REPORT  
 6600 M-1102-B

SERVICE CONDITIONS: DRIP 10000  
 NORMAL 1250  
 MAXIMUM 1950

REMOVE INSULATION IN AREA OF SUPPORT 6" ON EITHER SIDE ALL DIMENSIONS MEASURED TO CENTER LINE AND SPACING TO CENTER LINE CALL OUT DIMENSIONS TO CENTER LINE

1. REMOVE INSULATION IN AREA OF SUPPORT 6" ON EITHER SIDE ALL DIMENSIONS MEASURED TO CENTER LINE AND SPACING TO CENTER LINE CALL OUT DIMENSIONS TO CENTER LINE

2. SHOP WELD NO.

3. FIELD WELD NO.

4. BEND NO.

5. ITEM NO.

6. SHOP NO. TO BE STAMPED IN JOINTS CHARACTERS USING WORK NUMBER PAINT ON EACH SIDE AT APPROX. 10" INTERVALS

7. TO BE USED WITH FIELD WELD SYMBOL SPECIFYING THAT A MIN. OF 4" RANDOM SURPLUS PIPE SHALL BE LEFT BY FAB. SHOP AT EACH JOINT MARKED THIS SURPLUS SHALL BE CUT BY FIELD

ITEM NO.	DESCRIPTION	WEIGHT	ASTM	QTY
15	1/2" HEX NUTS			
14	1/2" ENG. 1/4" ROD P.L.T.S.			
13	1/2" X 1/2" ANGLE P.L.T.S.			
12	1/2" DIA. WEDGE ANCHORS			
11	STRUCTURAL TEE 4" X 1/2" X 1/2"			
10	1/2" X 1/2" X 1/2"			
9	1/2" X 1/2" X 1/2"			
8	1/2" X 1/2" X 1/2"			
7	1/2" X 1/2" X 1/2"			

NOTE: STARTUP NO. 509 INSULATION CLASS F THICK 1/2"

ISI-280

Zone 80  
 80-307-80-345



















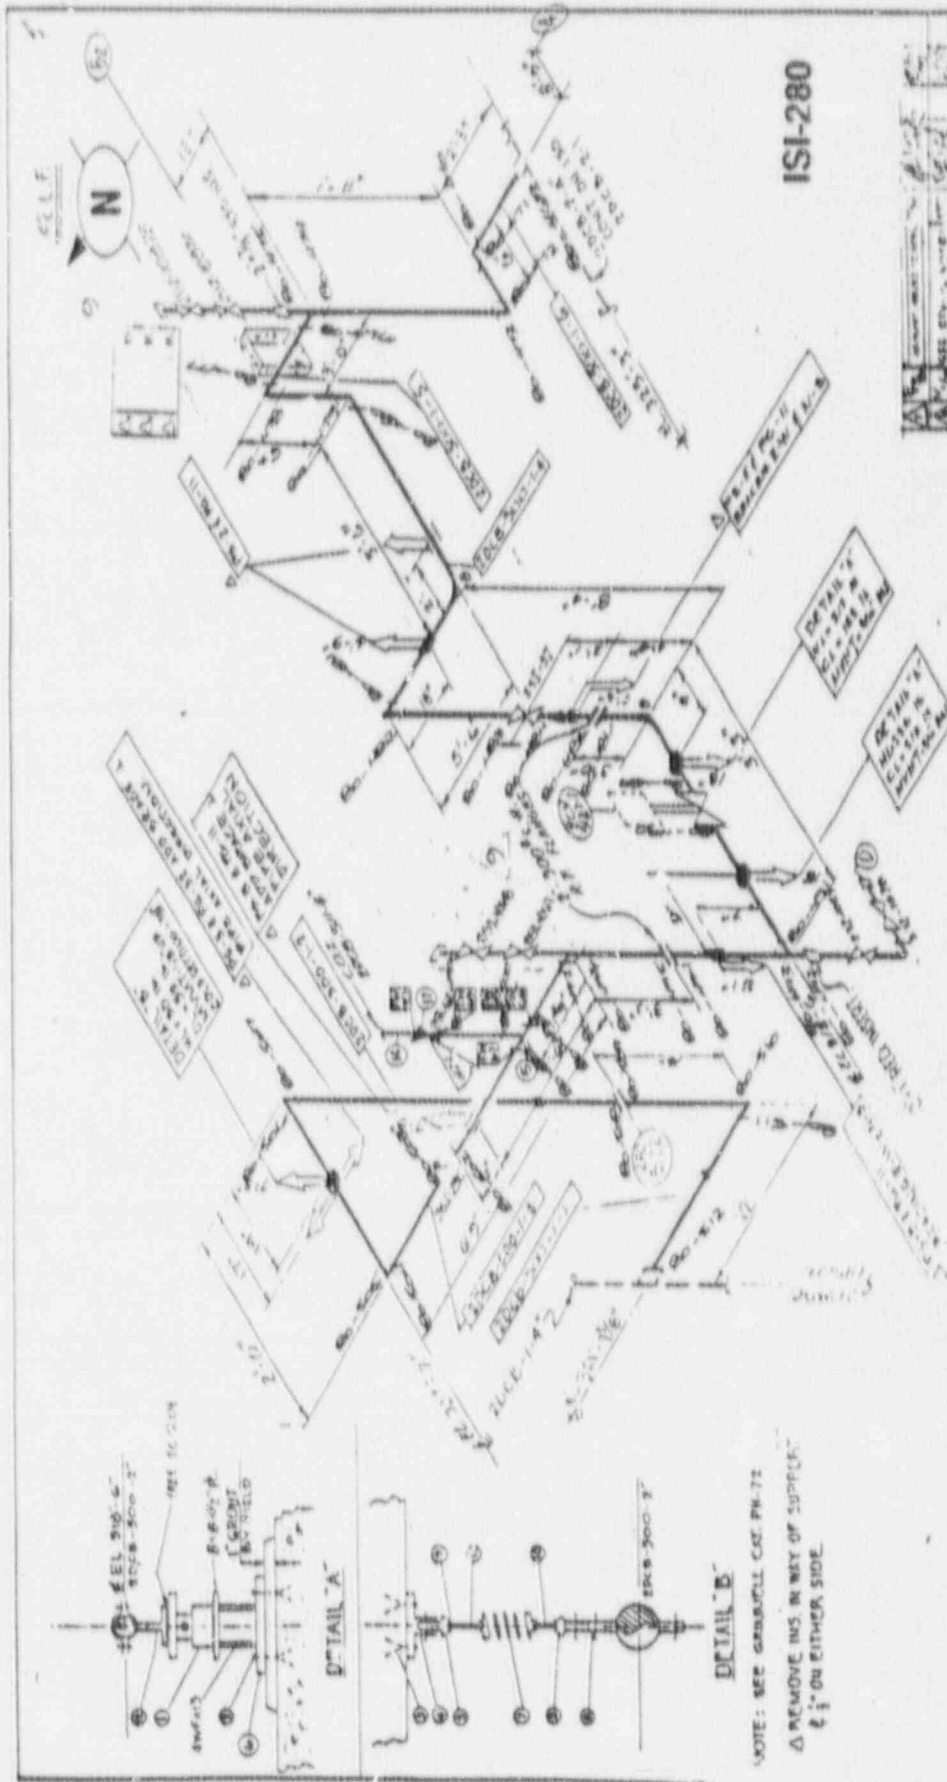

ISI-280

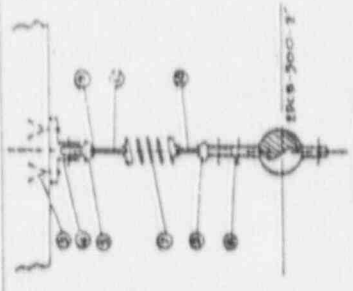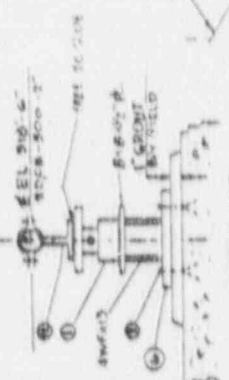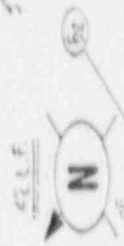

NOTE: SEE GRABULL CAT. PK-72  
 Δ REMOVE INS. IN WY OF SUPPORT  
 1" ON EITHER SIDE.

THIS DRAWING SUPERSEDES  
 FIELD SUGGESTED MODIFICATIONS

FILE NO. M-1151	DATE: 11-15-50
PROJECT: ARABAS NUCLEAR ONE	UNIT: 2
AREA: 24	VIEW: SET-O
SCALE: CONTAINMENT RATE	TYPE: SAFETY VALVE
NUMBER: 16600-2000-500-1	CLASS: 1(2)
DATE: 11-15-50	BY: 350
CHECKED: 11-15-50	APP: 350

- NOTES:
1. USE WELDING WITH 1/8" OF ANCHOR BOLT. WELDING SHALL BE DONE BY THE WELDER. WELDING SHALL BE APPROVED WITHOUT SPAD APPROVAL.
  2. ANCHOR BOLT CONNECTION TO SUPPORTING STRUCTURE.
  3. 1/2" - SHOP WELD NO.
  4. 1/2" - FIELD WELD NO.
  5. 1/2" - WELD NO.
  6. 1/2" - WELD NO.
  7. 1/2" - WELD NO.
  8. 1/2" - WELD NO.
  9. 1/2" - WELD NO.
  10. 1/2" - WELD NO.
  11. 1/2" - WELD NO.
  12. 1/2" - WELD NO.
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  14. 1/2" - WELD NO.
  15. 1/2" - WELD NO.
  16. 1/2" - WELD NO.
  17. 1/2" - WELD NO.
  18. 1/2" - WELD NO.
  19. 1/2" - WELD NO.
  20. 1/2" - WELD NO.

ITEM NO.	DESCRIPTION	QTY	UNIT
1	STEEL SHIP	1	EA
2	PIPE CLAMP	1	EA
3	PIPE CLAMP	1	EA
4	PIPE CLAMP	1	EA
5	PIPE CLAMP	1	EA
6	PIPE CLAMP	1	EA
7	PIPE CLAMP	1	EA
8	PIPE CLAMP	1	EA
9	PIPE CLAMP	1	EA
10	PIPE CLAMP	1	EA
11	PIPE CLAMP	1	EA
12	PIPE CLAMP	1	EA
13	PIPE CLAMP	1	EA
14	PIPE CLAMP	1	EA
15	PIPE CLAMP	1	EA
16	PIPE CLAMP	1	EA
17	PIPE CLAMP	1	EA
18	PIPE CLAMP	1	EA
19	PIPE CLAMP	1	EA
20	PIPE CLAMP	1	EA

BECHTEL  
 SAN FRANCISCO  
 ARABAS NUCLEAR ONE  
 AUXILIARY BUILDING  
 16600-2000-500-1

510

SEE BILL OF MATERIAL


















...treatment that they will not be  
...with various given by the leader to the barracks.

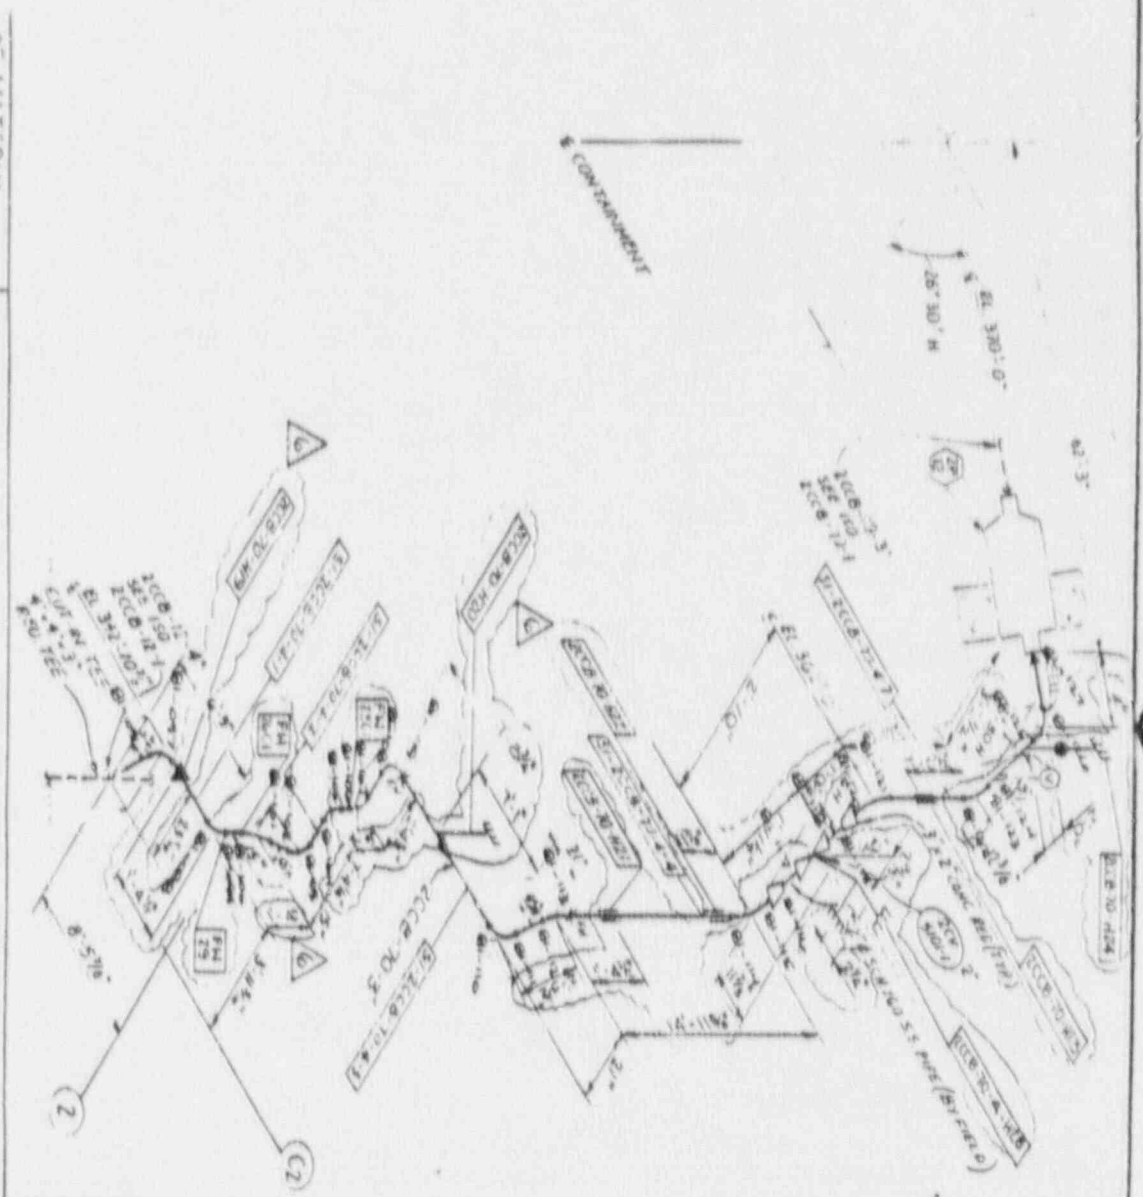

66 L F  
S/U 51  
N

REFERENCE DRAWINGS  
M 2110 REV. 28 P110 (CACC-45)  
M 2044 REV. 16 P1096 PLANT AREA 41  
M 2045 REV. 14  
M 2004 REV. 19

NO.	DESCRIPTION	DATE	BY	CHKD.	APP.
1	ISSUED FOR CONSTRUCTION	11/15/66	J. W. BROWN	J. W. BROWN	J. W. BROWN
2	REVISED TO SHOW CHANGES	11/15/66	J. W. BROWN	J. W. BROWN	J. W. BROWN
3	REVISED TO SHOW CHANGES	11/15/66	J. W. BROWN	J. W. BROWN	J. W. BROWN
4	REVISED TO SHOW CHANGES	11/15/66	J. W. BROWN	J. W. BROWN	J. W. BROWN
5	REVISED TO SHOW CHANGES	11/15/66	J. W. BROWN	J. W. BROWN	J. W. BROWN
6	REVISED TO SHOW CHANGES	11/15/66	J. W. BROWN	J. W. BROWN	J. W. BROWN

ISI-281

**BECHTEL**  
SAN FRANCISCO  
ARIZONA POWER & LIGHT COMPANY  
ARIZONA NUCLEAR ONE  
UNIT 2  
ISOMETRIC-CONTAINMENT AUX BLDG  
SAFETY DIRECTION

66002 2CCB-70-4 6

OF MATERIAL

DESCRIPTION	QUANTITY
MANIF. SI-2CCB-70-4-1	1
SI-2CCB-70-4-2	1
SI-2CCB-70-4-3	1
SI-2CCB-70-4-4	1
SI-2CCB-70-4-5	1
SI-2CCB-70-4-6	1
SI-2CCB-70-4-7	1
SI-2CCB-70-4-8	1
SI-2CCB-70-4-9	1
SI-2CCB-70-4-10	1
SI-2CCB-70-4-11	1
SI-2CCB-70-4-12	1
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SI-2CCB-70-4-14	1
SI-2CCB-70-4-15	1
SI-2CCB-70-4-16	1
SI-2CCB-70-4-17	1
SI-2CCB-70-4-18	1
SI-2CCB-70-4-19	1
SI-2CCB-70-4-20	1
SI-2CCB-70-4-21	1
SI-2CCB-70-4-22	1
SI-2CCB-70-4-23	1
SI-2CCB-70-4-24	1
SI-2CCB-70-4-25	1
SI-2CCB-70-4-26	1
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SI-2CCB-70-4-28	1
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SI-2CCB-70-4-30	1
SI-2CCB-70-4-31	1
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SI-2CCB-70-4-37	1
SI-2CCB-70-4-38	1
SI-2CCB-70-4-39	1
SI-2CCB-70-4-40	1
SI-2CCB-70-4-41	1
SI-2CCB-70-4-42	1
SI-2CCB-70-4-43	1
SI-2CCB-70-4-44	1
SI-2CCB-70-4-45	1
SI-2CCB-70-4-46	1
SI-2CCB-70-4-47	1
SI-2CCB-70-4-48	1
SI-2CCB-70-4-49	1
SI-2CCB-70-4-50	1

A B C D E F G H I J K L M N O P Q R S T U V W X Y Z

Zone B1 B 1C  
B1-076 B1-127


9 L.F.  
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REV. NOTES

REVISED FOR CONSTRUCTION  
 ADDING SPALL IDENTIFICATION  
 ACCORD TO CHG. DRAWING  
 DATE 4-2

REFERENCE DRAWINGS

M-2760 REVISED (2008.7.8)  
 M-2760 REVISED (2008.7.8)  
 M-2760 REVISED (2008.7.8)

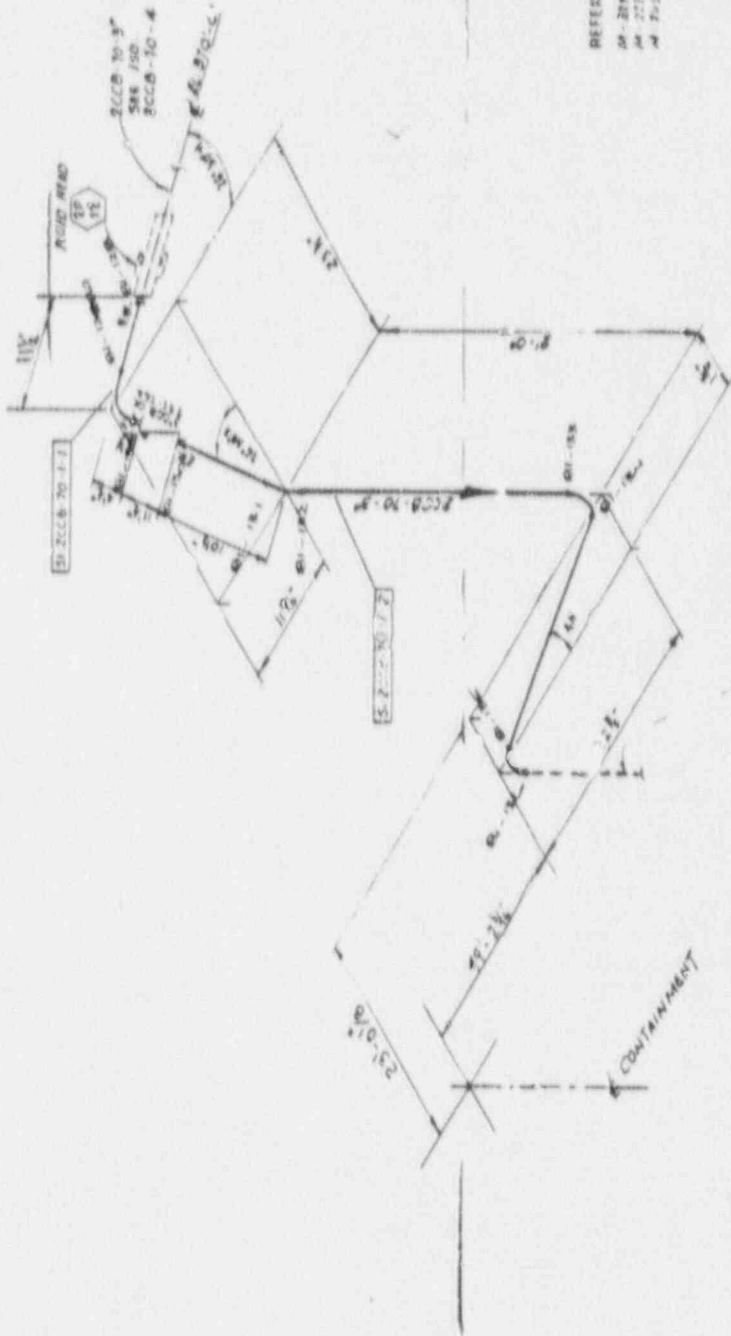

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 1-10

NO.	DATE	DESCRIPTION	BY	CHECKED
1	05/08/08	ISSUED FOR CONSTRUCTION	...	...
2	05/08/08	...	...	...
3	05/08/08	...	...	...
4	05/08/08	...	...	...
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BECHTEL  
 ARKANSAS POWER & LIGHT COMPANY  
 ARKANSAS NUCLEAR ONE  
 UNIT 2

ISOMETRIC CONFORMANCE  
 SAFETY INJECTION SYSTEM

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ISI-281

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Zone 81  
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 81-13

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1 of 1




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REFERENCE DRAWINGS  
 M-2250 PM 27 P & D 1100 P 1  
 M-2252 PM 28 P & D 1100 P 1  
 M-2257 PM 29 P & D 1100 P 1



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BECHTEL  
 SAN FRANCISCO  
 ARKANSAS POWER & LIGHT COMPANY  
 ARKANSAS NUCLEAR ONE  
 UNIT 2

ISOMETRIC COLLECTOR SYSTEM  
 SAFETY COLLECTION SYSTEM  
 660020002-7034

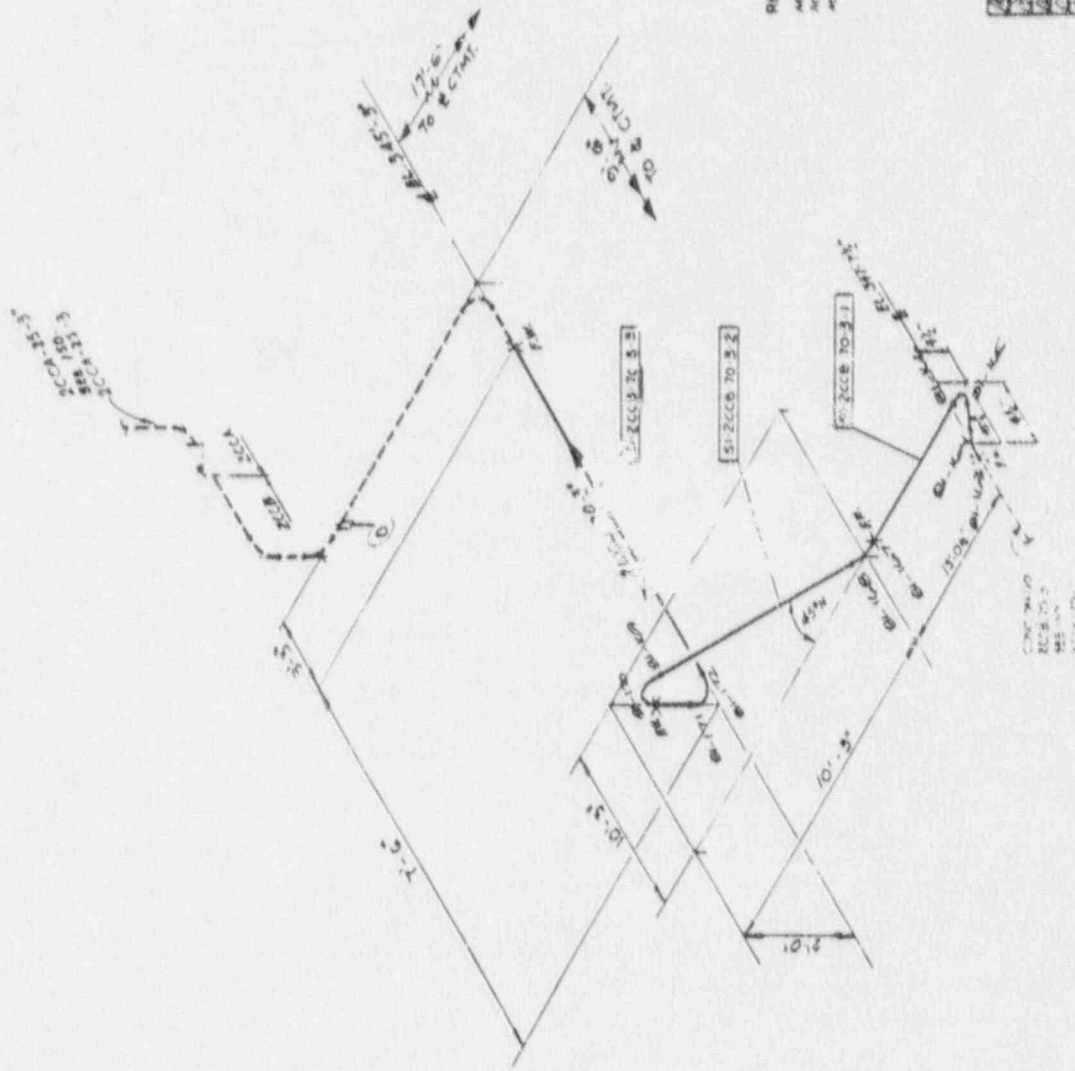ISI-281


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Zone 81  
 81-103-8-172

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1. E. Y.



REFERENCE	PRID NO. M-2230	AREA NO. 25	ELEV.	NO. DATE	ISSUED BY	REVISION	BY	DATE
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98	1	1" 6000+ TRG. CAP			
99	1	1" 6000+ TRG. CAP			
100	1	1" 6000+ TRG. CAP			

Zone 81  
81-172A → 81-180

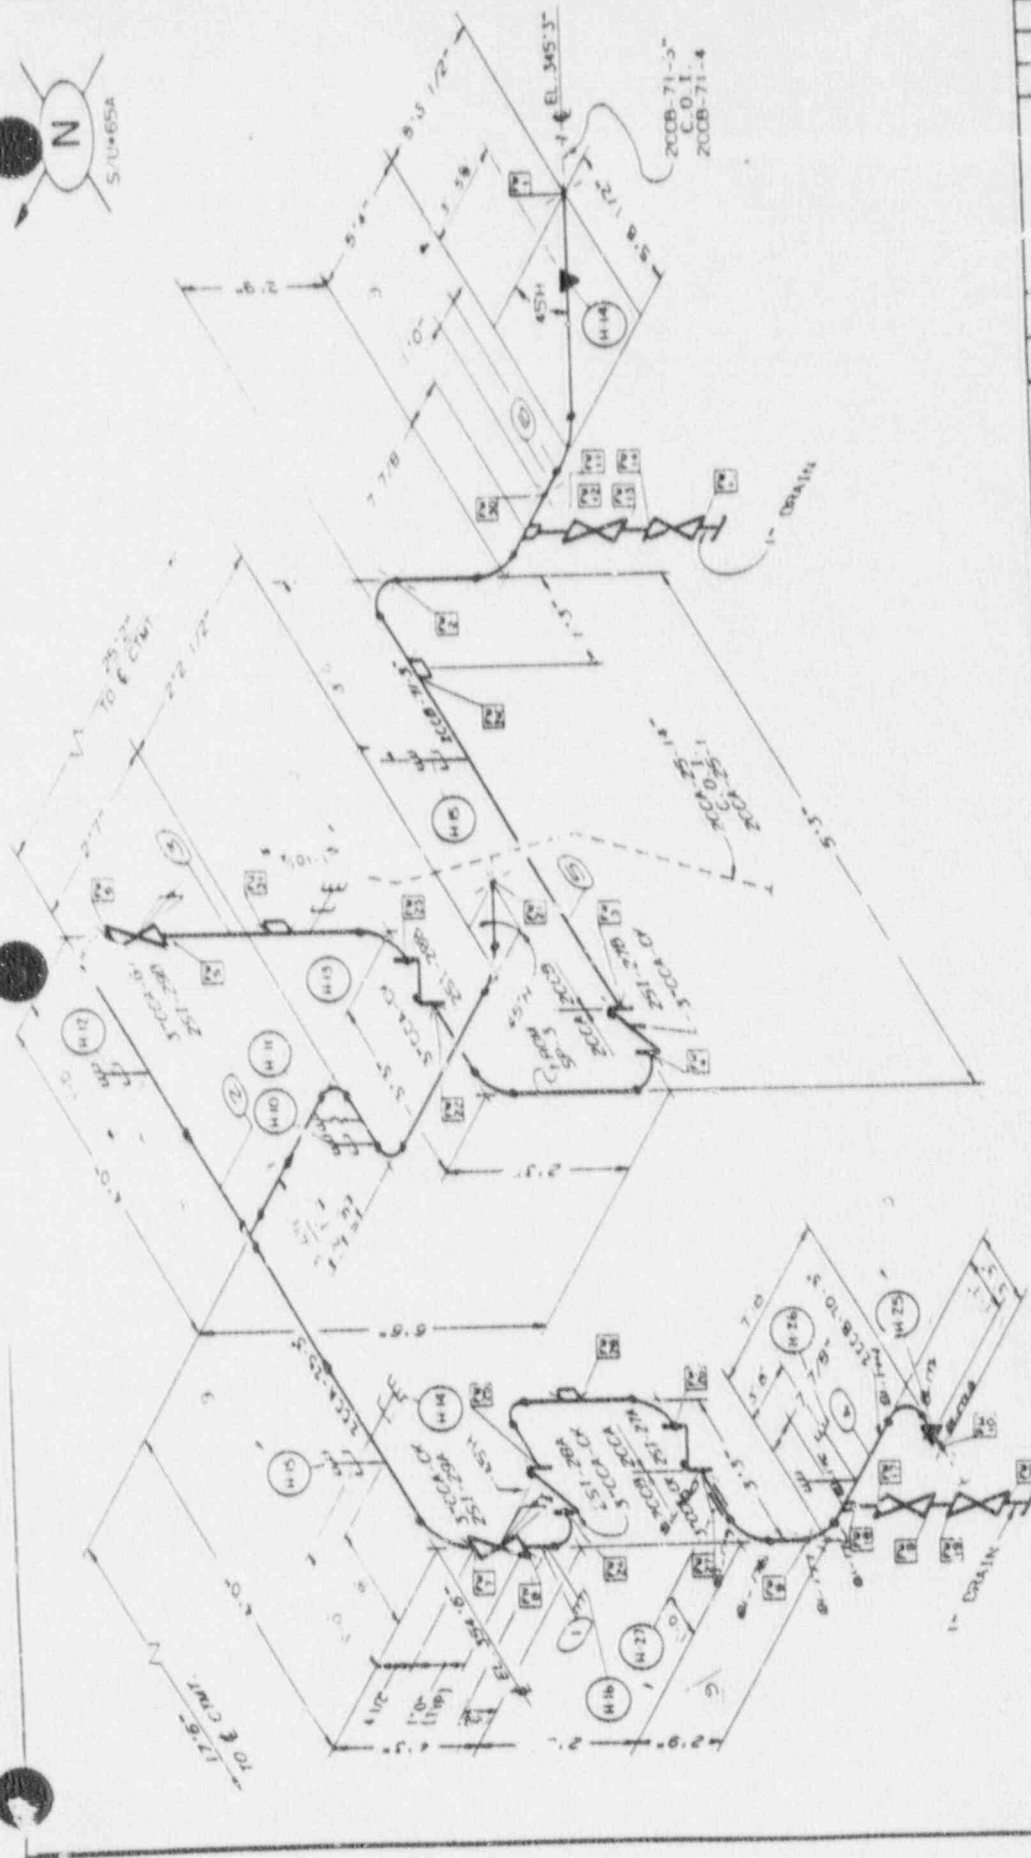ISI-281

ARKANSAS POWER AND LIGHT COMPANY  
ARKANSAS NUCLEAR ONE UNIT 2  
LARGE PIPE ISOMETRIC SAFETY INJECTION SYSTEM  
DRAWING NO. ZCCA-25-3  
REV. 9

















ATTACHMENT 3

CODE CASES UTILIZED IN ISI PROGRAM

CODE CASES FOR ANO-2 INSERVICE INSPECTION PROGRAM

- N-98 Ultrasonic Examination - Calibration Block Tolerances, Section XI
- N-113-1 Basic Calibration Block for Ultrasonic Examinations of Welds 10 Inch to 14 Inch Thick, Section XI, Division 1
- N-335 Calibration Block for Angle Beam Ultrasonic Examination of Large Fittings in Accordance with Appendix III-3410, Section XI, Division 1
- N-356 Certification Period for Level III NDE Personnel, Section XI, Division 1, 2, and 3
- N-427 Code Cases in Inspection Plans, Section XI, Division 1
- N-435-1 Alternative Examination Requirements for Vessels with Wall Thickness 2 Inch or Less, Section XI, Division 1
- N-436-1 Alternative Methods for Evaluation of Flaws in Austenitic Piping, Section XI, Division 1
- N-445 Use of Later Editions of SNT-TC-1A for Qualification of Nondestructive Examination Personnel, Section XI, Division 1, 2, and 3