

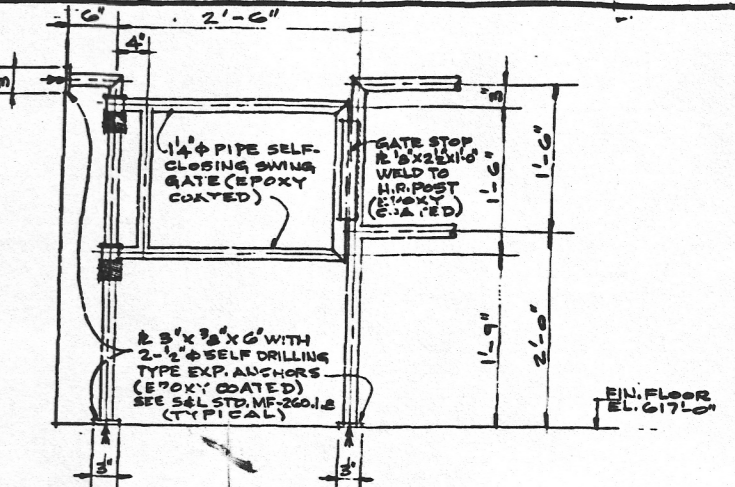



NON-SAFETY RELATED

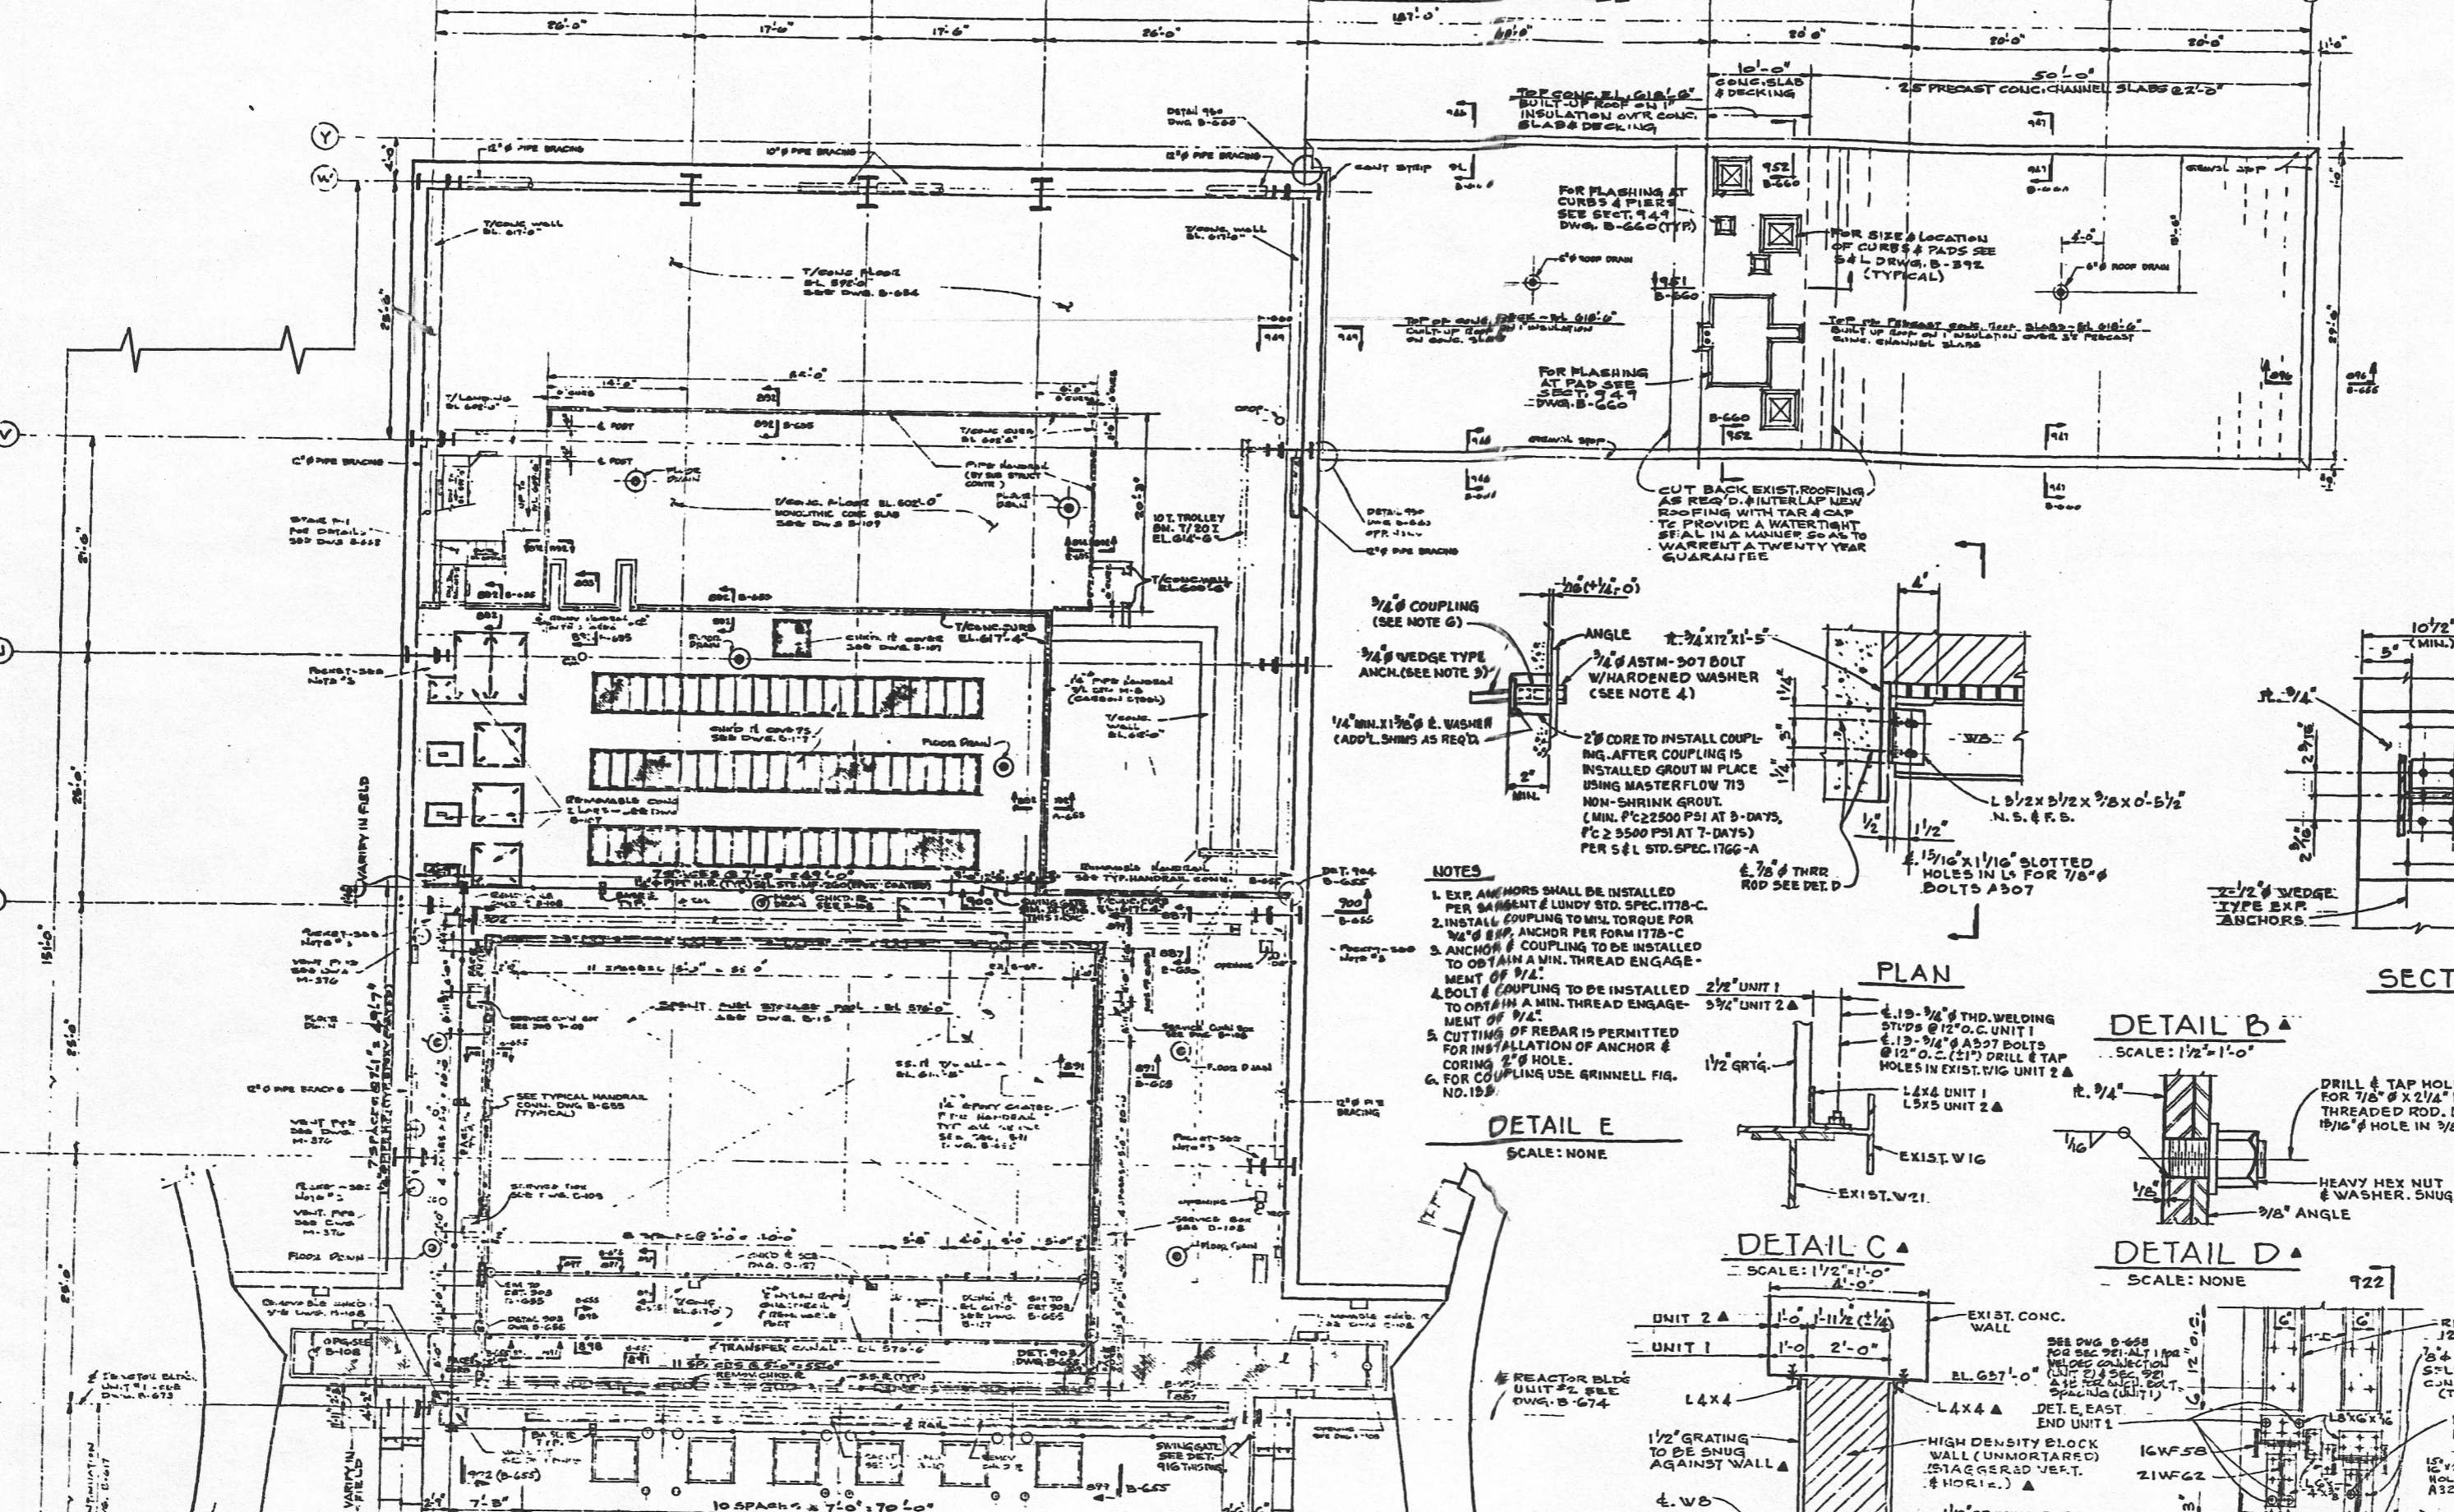


DETAIL 916
SCALE: 1/2"=1'-0"

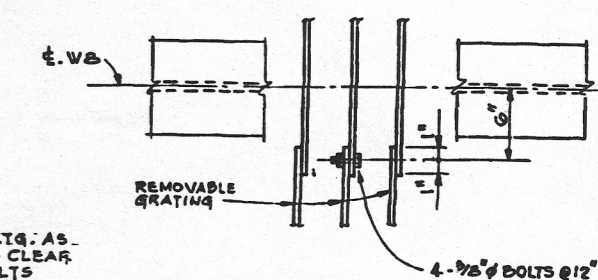


DETAIL A
SCALE: 1/2"=1'-0"

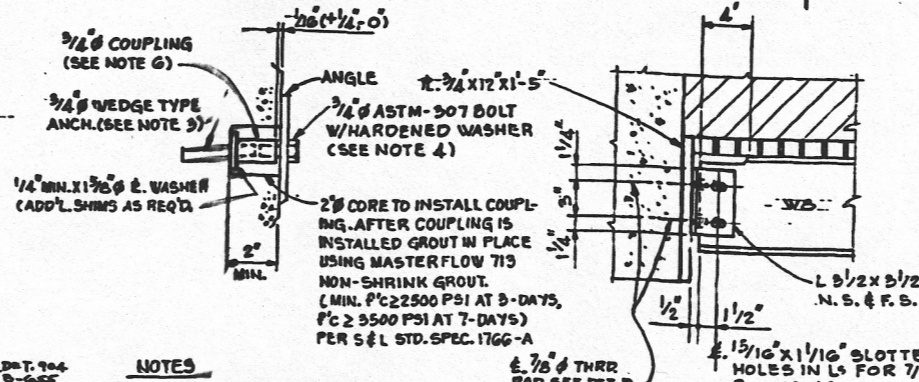


DETAIL E
SCALE: NONE

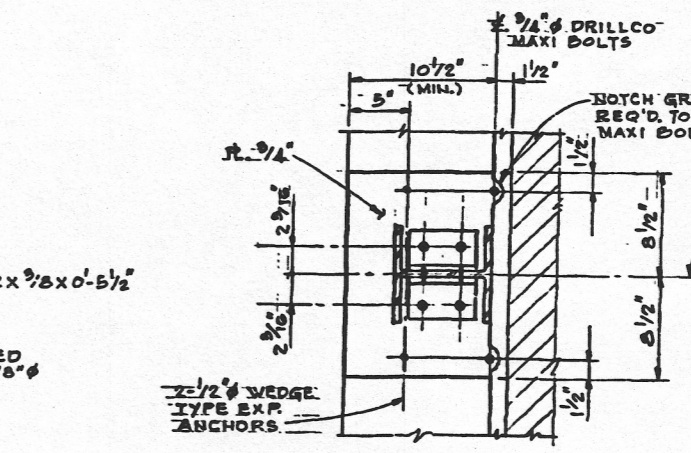

DETAIL B
SCALE: 1/2"=1'-0"

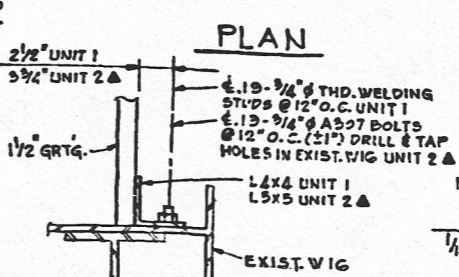

DETAIL C
SCALE: 1/2"=1'-0"

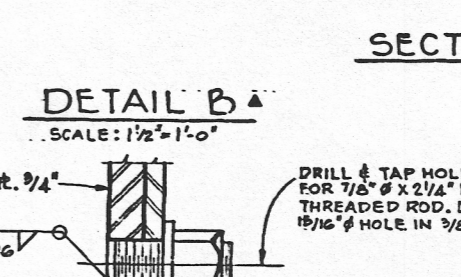


DETAIL D
SCALE: NONE

NOTES


1. EXP. ANCHORS SHALL BE INSTALLED PER 94.10.1.1 AND LINDY STD SPEC. ITB-C.
2. INSTALL COUPLING TO MIN. TORQUE FOR 7/8" DIA. ANCHOR PER FORM 1775-C.
3. ANCHOR & COUPLING TO BE INSTALLED TO OBTAIN A MIN. THREAD ENGAGEMENT OF 7/8".
4. BOLT & COUPLING TO BE INSTALLED TO OBTAIN A MIN. THREAD ENGAGEMENT OF 7/8".
5. CUTTING OF REBAR IS PERMITTED FOR INSTALLATION OF ANCHOR & COUPLING. 2" MIN. HOLE.
6. FOR COUPLING USE RINCHER FIG. NO. 159.

FUEL HANDLING BLD'G.
PLAN EL. 617'-0"


MONOLITHIC CONC. FLOOR FINISH UNLESS NOTED

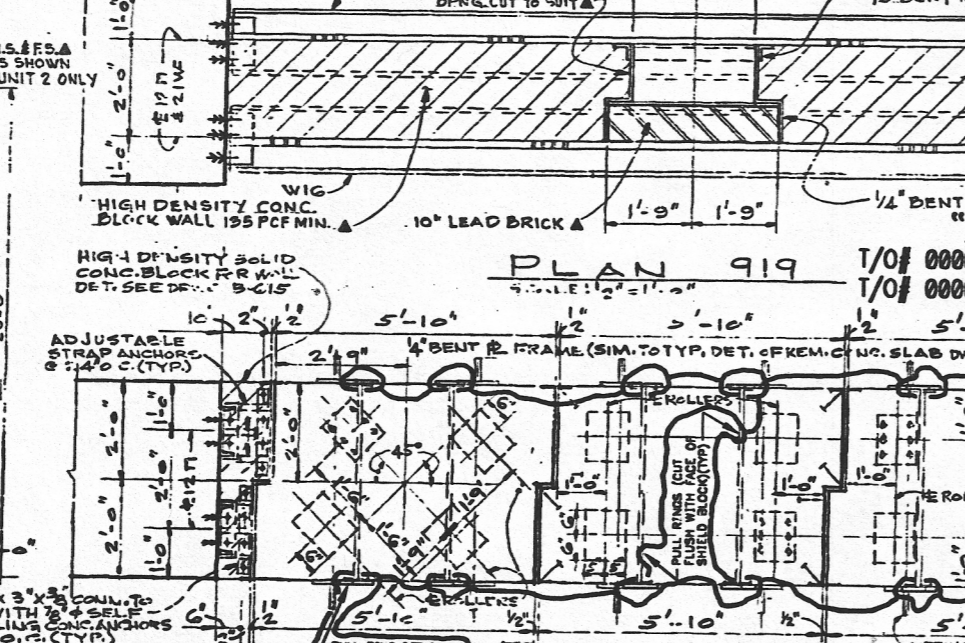


PLAN 919
SCALE: 1/2"=1'-0"

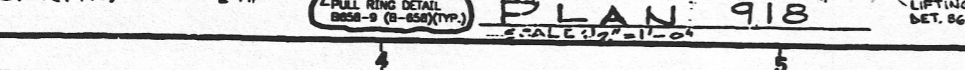


PLAN 918
SCALE: 1/2"=1'-0"

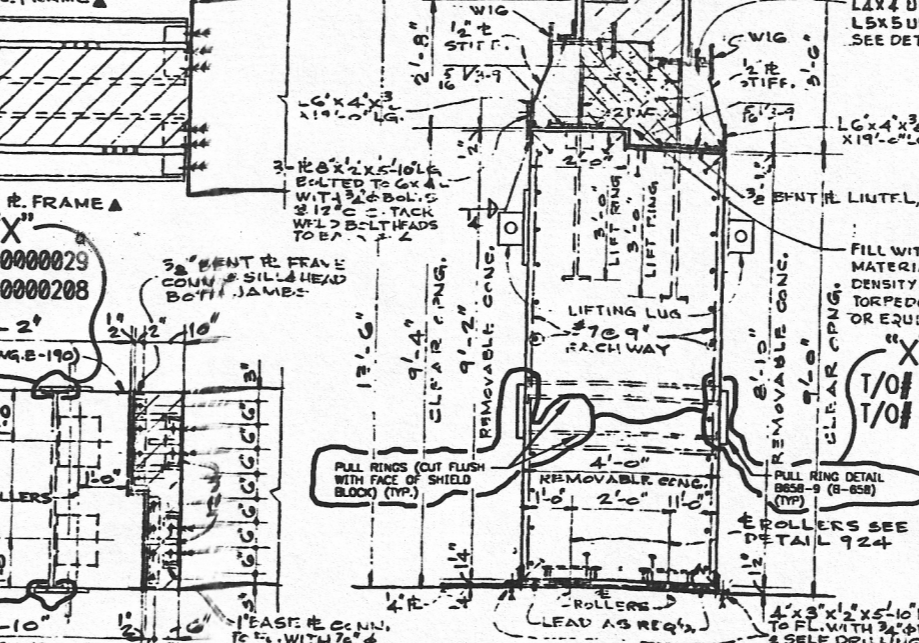


SECTION 920
SCALE: 1/2"=1'-0"

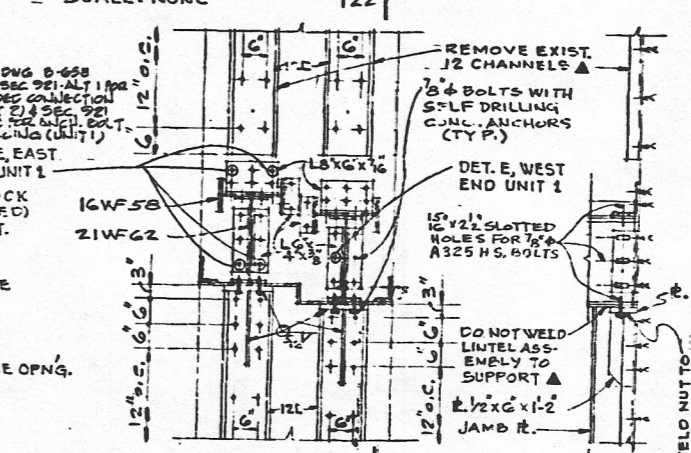


SECTION 921
SCALE: 1/2"=1'-0"

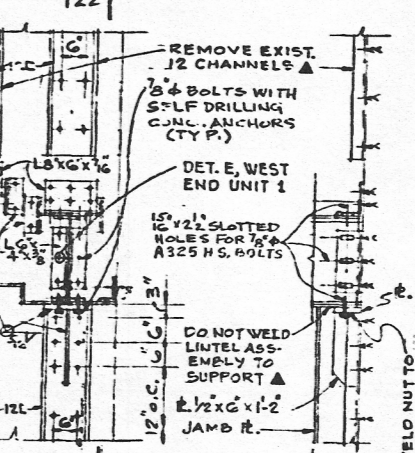

SECTION 922
SCALE: 1/2"=1'-0"

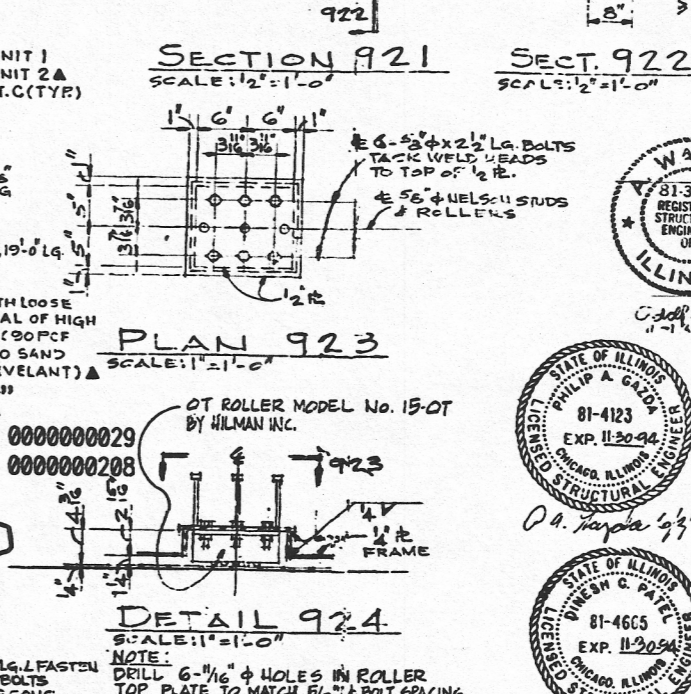

PLAN 923
SCALE: 1/2"=1'-0"

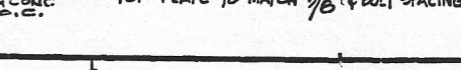

DETAIL 924
SCALE: 1/2"=1'-0"



- KEY PLAN
- NOTES
1. FROM AN ARCHITECTURAL OR MECHANICAL DRAWING, THE DIMENSIONS OF THE WORK SHALL BE TAKEN FROM THE DIMENSIONS OF THE WORK AS SHOWN ON THE DRAWING.
 2. THE DIMENSIONS OF THE WORK SHALL BE TAKEN FROM THE DIMENSIONS OF THE WORK AS SHOWN ON THE DRAWING.
 3. THE DIMENSIONS OF THE WORK SHALL BE TAKEN FROM THE DIMENSIONS OF THE WORK AS SHOWN ON THE DRAWING.
 4. ALL WORK SHALL BE DONE IN ACCORDANCE WITH THE REQUIREMENTS OF THE SPECIFICATIONS AND THE DRAWINGS.
 5. THE DIMENSIONS OF THE WORK SHALL BE TAKEN FROM THE DIMENSIONS OF THE WORK AS SHOWN ON THE DRAWING.
 6. THE DIMENSIONS OF THE WORK SHALL BE TAKEN FROM THE DIMENSIONS OF THE WORK AS SHOWN ON THE DRAWING.
 7. THE DIMENSIONS OF THE WORK SHALL BE TAKEN FROM THE DIMENSIONS OF THE WORK AS SHOWN ON THE DRAWING.
 8. THE DIMENSIONS OF THE WORK SHALL BE TAKEN FROM THE DIMENSIONS OF THE WORK AS SHOWN ON THE DRAWING.
 9. THE DIMENSIONS OF THE WORK SHALL BE TAKEN FROM THE DIMENSIONS OF THE WORK AS SHOWN ON THE DRAWING.
 10. THE DIMENSIONS OF THE WORK SHALL BE TAKEN FROM THE DIMENSIONS OF THE WORK AS SHOWN ON THE DRAWING.

REFERENCE DRAWINGS

NO.	DESCRIPTION	DATE
1
2
3
4
5
6
7
8
9
10

DRAWING RELEASE APPROVAL

REV. SPEC. NO. DATE

W. J. ...

THIS DRAWING INCLUDES NUCLEAR SAFETY-RELATED EQUIPMENT AND/OR COMPONENTS - EXCEPT AS NOTED

ComEd
Chicago, Illinois
Zion Station 22

FUEL HANDLING BUILDING OPERATING FLOOR PLAN EL. 617'-0" ZION STATION UNIT 1 & 2

SCALE: 1/2"=1'-0" (SEE NOTES)
DATE: 11/25/98
DRAWN BY: D. V. OLIVARES
ENG. BY: ...
FILENAME: 101NS
SHEET NO. B-657

D46