


A
B
C
D
E
F
G
H
J
K

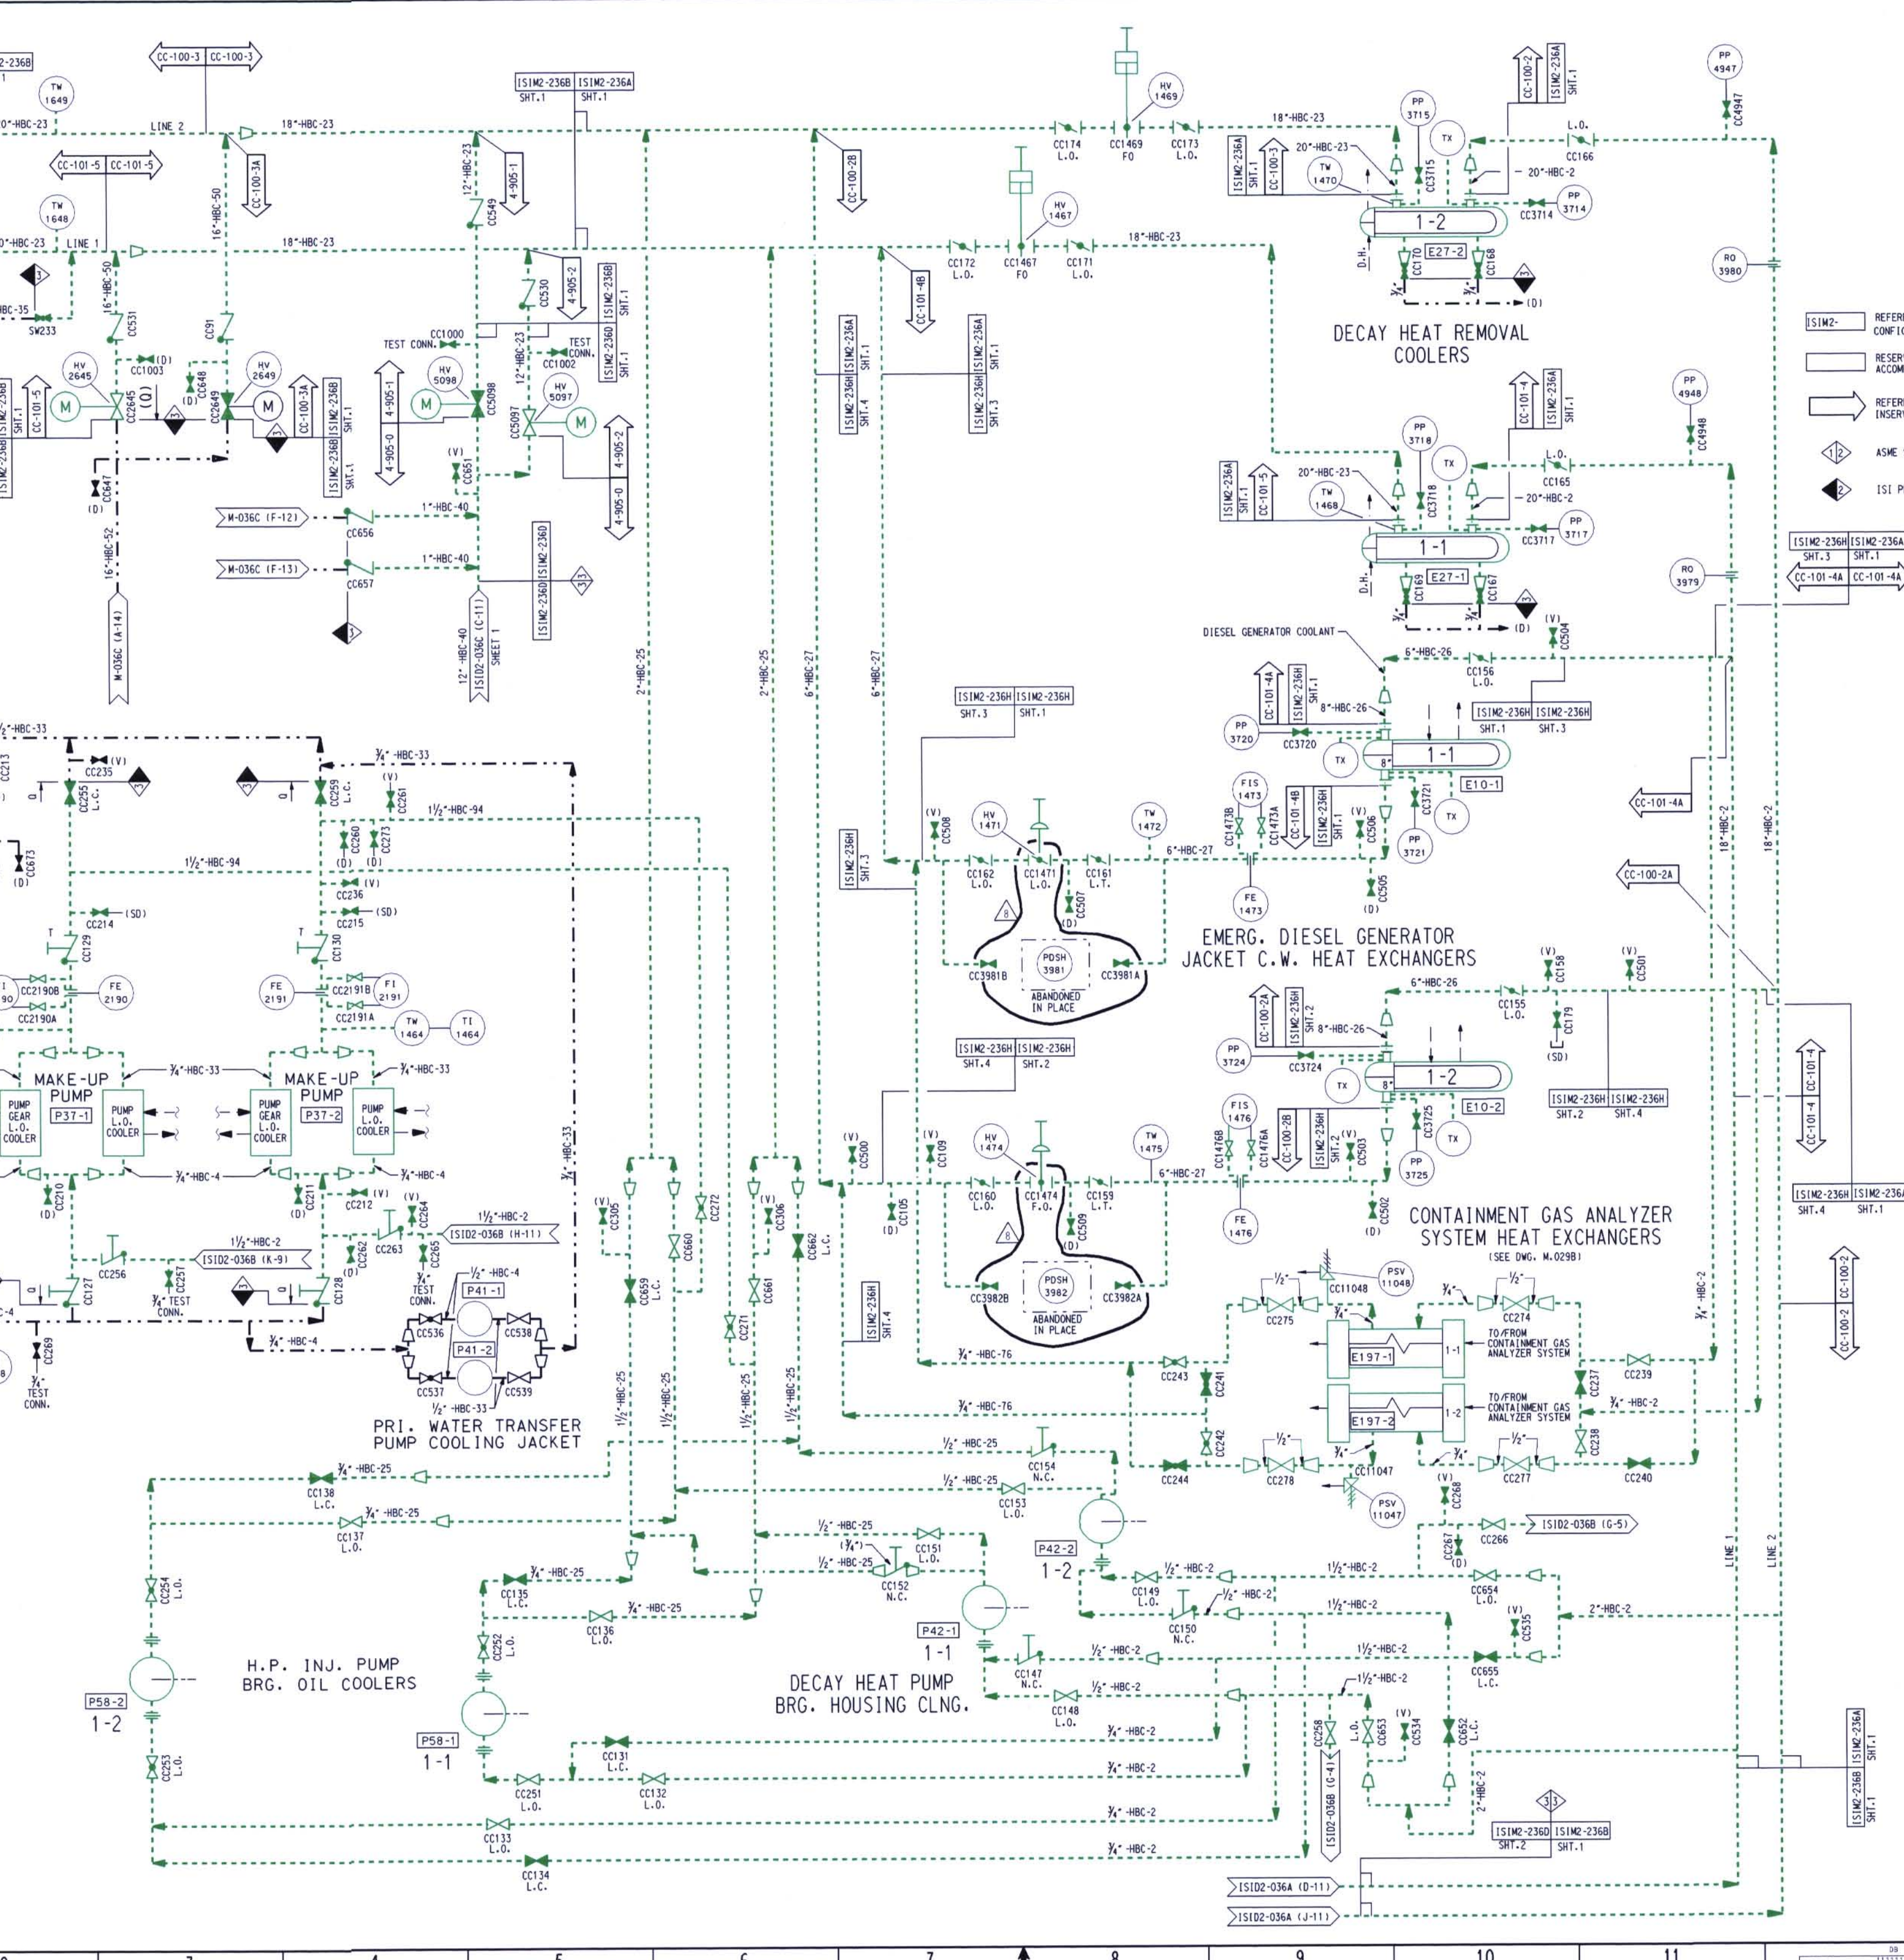

- ISIM2- REFERENCE TO THE PIPING ISOMETRIC DRAWING FOR DETAILS ON THE PIPING CONFIGURATION, AND THE LOCATION AND IDENTIFICATION OF WELDS AND SUPPORTS.
- RESERVED FOR SPECIAL ISI REQUIREMENTS. (MAY BE) ACCOMPANIED BY SPECIFIC NOTES.
- REFERENCE TO THE ISI ITEM NUMBER DESIGNATION USED IN THE FIRST 10 YEAR INSERVICE INSPECTION INTERVAL.
- ASME SECTION XI CLASS CHANGE
- ISI PROGRAM BOUNDARY

- NOTES:**
1. DELETED
 2. FOR ISI BOUNDARY DIAGRAM INDEX SHEET AND GENERAL NOTES, SEE ISID2-001.
 3. FOR PIPING SYMBOLS AND P & ID INDEX, SEE DRAWING M-001.
 4. UNLESS OTHERWISE NOTED, ALL VENT CONNECTIONS ARE 3/4" AND DRAIN CONNECTIONS ARE 1". LINE IDENTIFICATION IS THE SAME AS THE HEADER.

D-027

1	INC. DCN ISID2-036B-24 AND 25 PER MOD 87-0029 SUP. 00	SBW		
2	INC. DCN ISID2-036B-23 PER DDR 00-1766			"INITIALS ON FILE"
3	INC. DCN ISID2-036B-21 PER DDR 98-0052			"INITIALS ON FILE"
4	INC. DCN ISID2-036B-19 FOR DCN 94-0083 AND DCN ISID2-036B-20 FOR DDR 95-2486			"INITIALS ON FILE"
5	ISSUED FOR SECOND 10 YEAR ISI PROGRAM	JJK	ZFB	TWB
6		BY	CHK	ENGR.
7		DATE	DATE	DATE
8		DESIGNED	DRWN	CB
SCALE N.T.S.				
DAVIS-BESSE NUCLEAR POWER STATION UNIT NO. 1				
THE TOLEDO Edison COMPANY				
INSERVICE INSPECTION DIAGRAM COMPONENT COOLING WATER SYSTEM				
DRAWING NO.				REV.
ISID2-036B				8